


COMHAIRLE CONTAE MHAIGH EO MAYO COUNTY COUNCIL


Architects Department

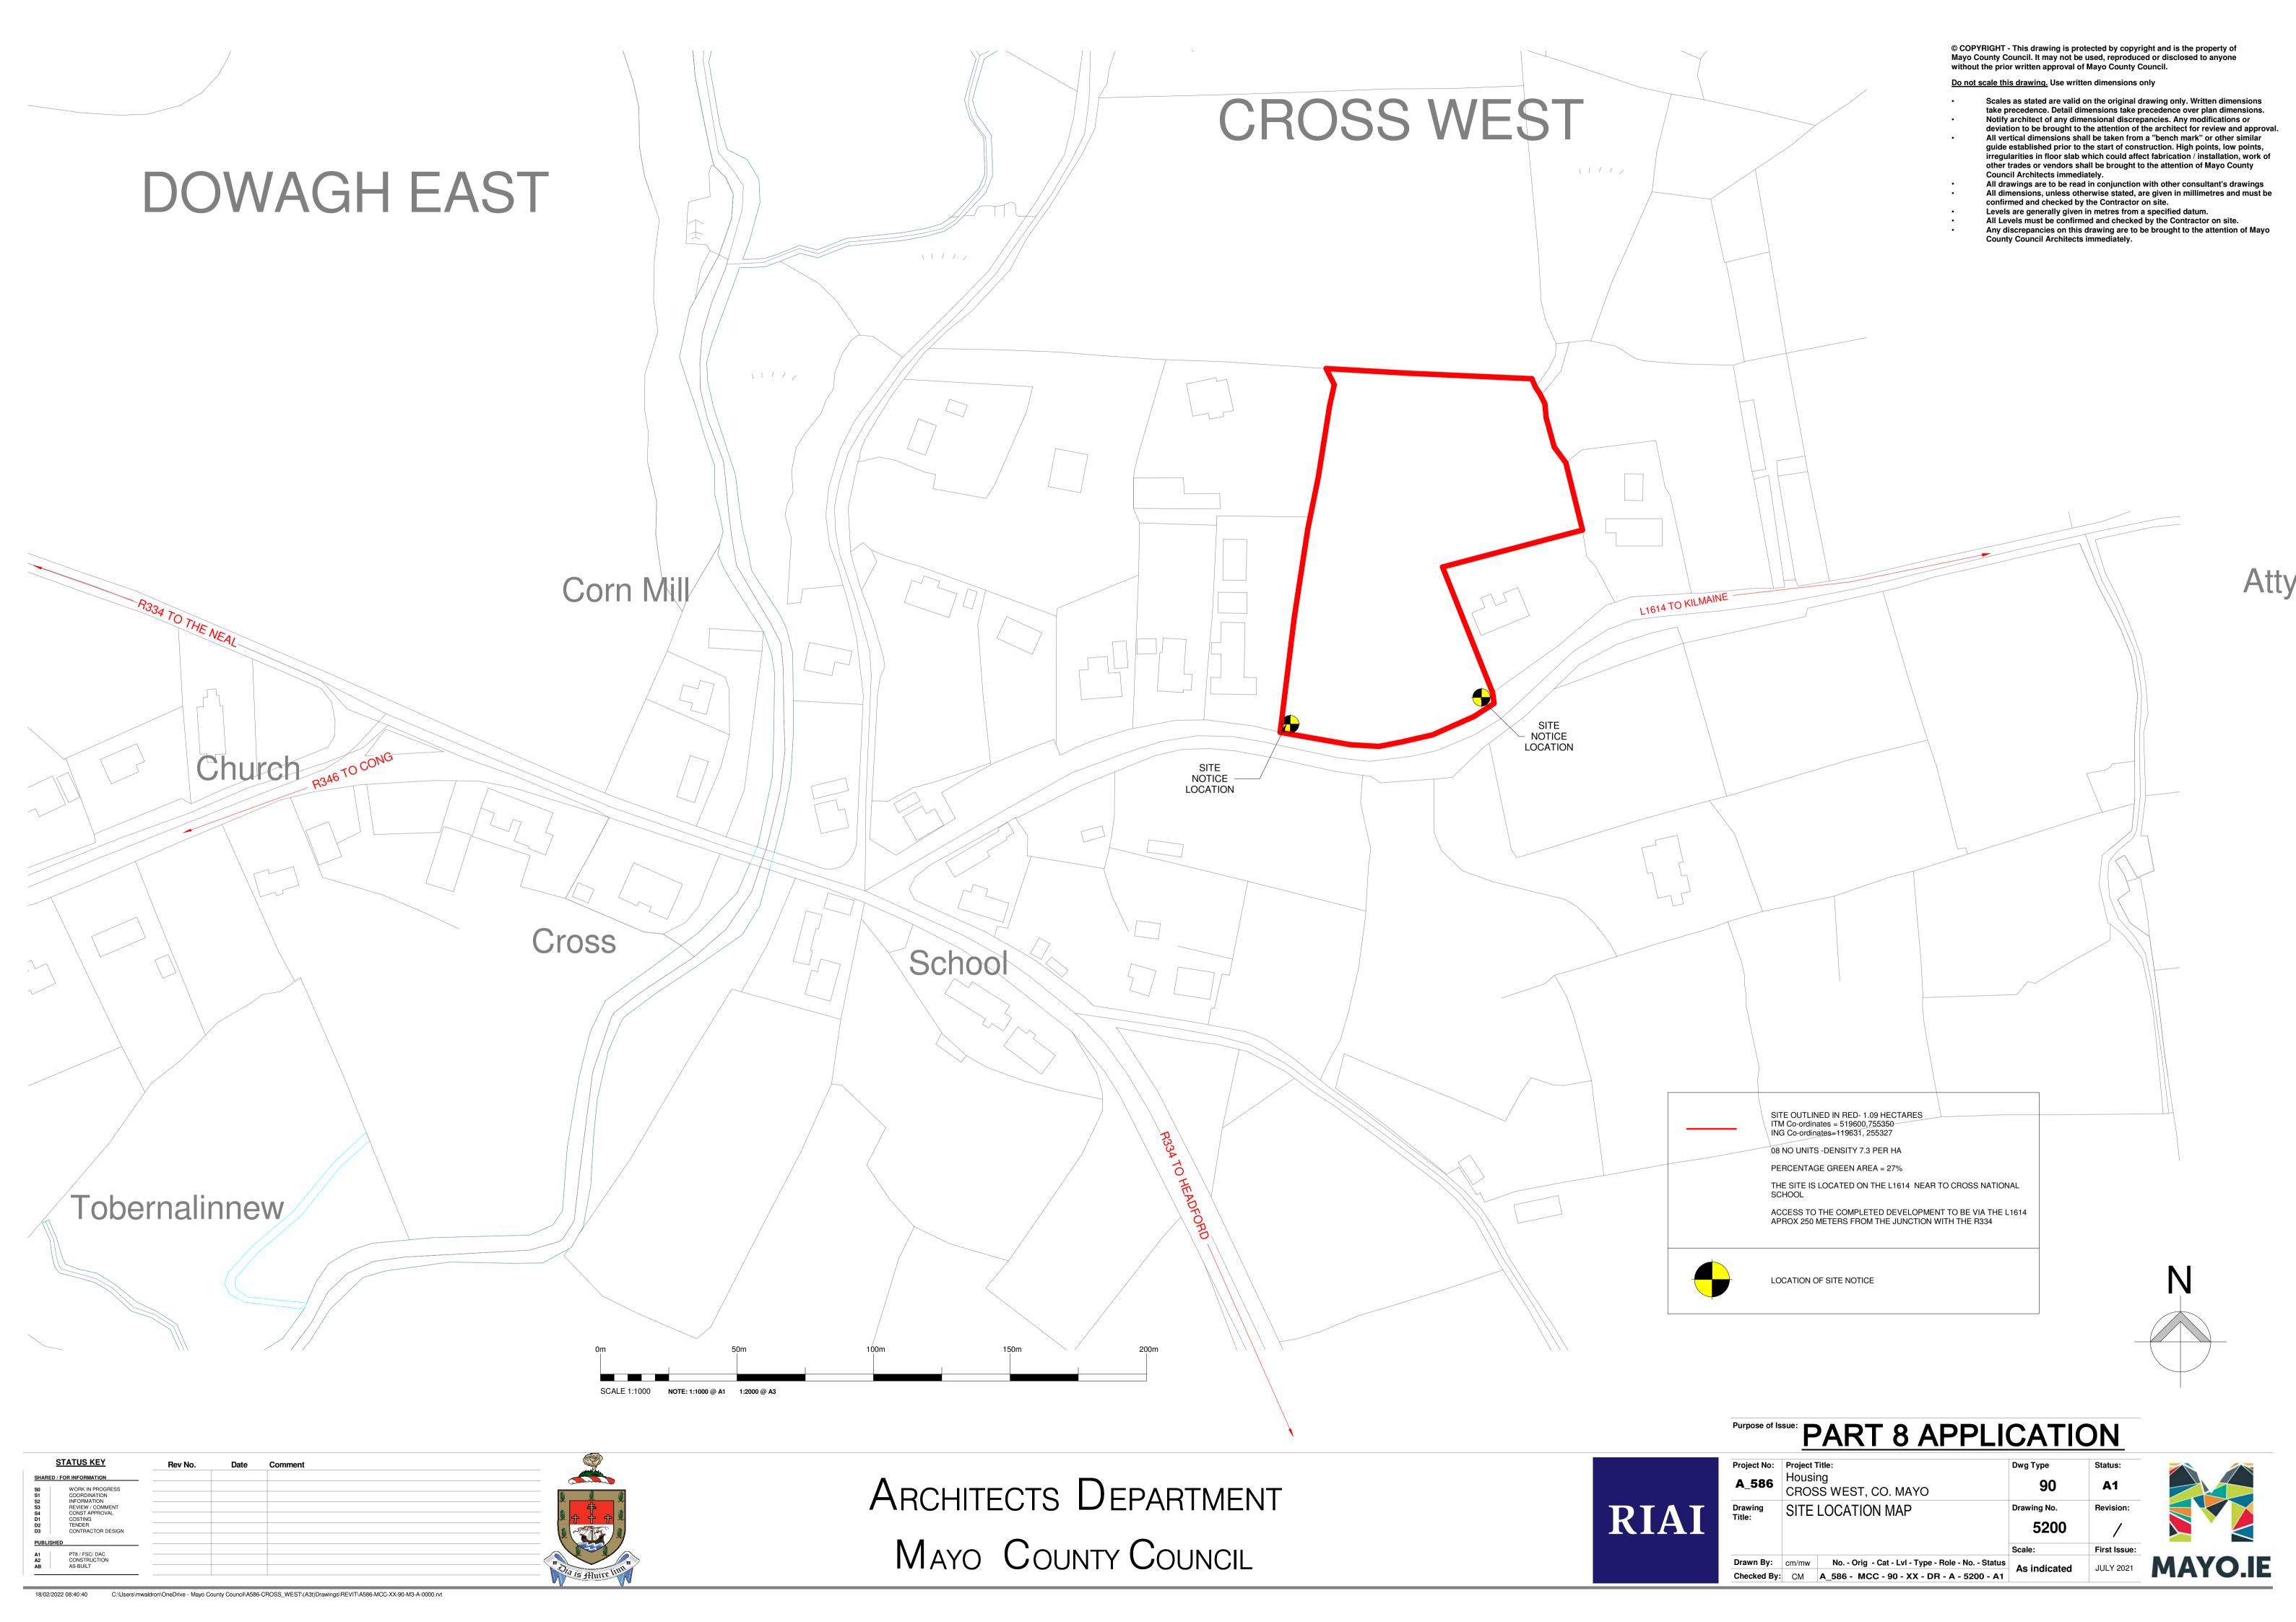

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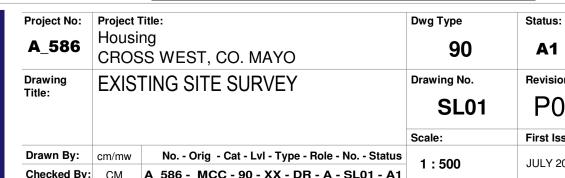


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All Levels must be confirmed and checked by the Contractor on site. Any discrepancies on this drawing are to be brought to the attention of Mayo County Council Architects immediately. PROPOSED DWELLING LOCATIONS SHOWN IN RED N 755,400 N 755,400 N 755,300 N 755,300 SITE NOTICE SITE OUTLINED IN RED- 1.09 HECTARES ITM Co-ordinates = 519600,755350 ING Co-ordinates=119631, 255327 LOCATION 08 NO UNITS -DENSITY 7.3 PER HA PERCENTAGE GREEN AREA = 27% SITE NOTICE — LOCATION THE SITE IS LOCATED ON THE L1614 NEAR TO CROSS NATIONAL ACCESS TO THE COMPLETED DEVELOPMENT TO BE VIA THE L1614 APROX 250 METERS FROM THE JUNCTION WITH THE R334 LOCATION OF SITE NOTICE

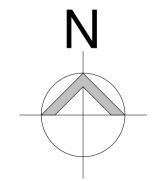

ABP APPLICATION A_586 Housing CROSS WEST, CO. MAYO

RIAI







SCALE 1:500 NOTE: 1:500 @ A1 1:1000 @ A3

SITE OUTLINED IN RED- 1.09 HECTARES ITM Co-ordinates = 519600,755350 ING Co-ordinates=119631, 255327 8 NO UNITS -DENSITY 7.3 PER HA ENTRANCE VISIBILITY ZONE MEASURED 90M ALONG ROADSIDE CARRIAGEWAY EACH SIDE OF NEW ENTRANCE- (SET BACK 3M). LOCAL ROAD HAS 80KM SPEED LIMIT. LOCATION OF SITE NOTICE INDICATES FLOOD RISK ZONE

MATERIALS: EXTERNAL ROOF FINISH: PITCHED ROOFS FINISHED IN SLATE BLUE BLACK IN (EXTERNAL) COLOUR EXTERNAL WINDOWS & DOORS : TIMBER ALU CLAD FRAMES WITH HIGHLY EFFICIENT GLAZING (MAX 0.8W/MK) -FINISHED IN SELECTED COLOURS TO

> **EXTERNAL WALLS: GENERALLY MASONRY WITH RENDERED FINISH PAINTED** TO SELECTED NEUTRAL COLOUR **DECORATIVE METAL FINISH:** METAL FINISH WITH STANDING SEAM PROFILE IN NEUTRAL COLOUR TO SELECTED AREAS (DORMER WALL FINISHES AND PORCH CANOPY FASCIAS)

> CONSTRUCTION 0F 08 NO. DWELLINGS COMPRISING OF 05 NO. 2 BEDROOMED DORMER SCALE TWO STOREY HOUSES AND 3 NO. 3 BEDROOMED DORMER SCALE TWO STOREY HOUSES IN A SEMI-DETACHED ARRANGEMENT. SCALE, MASSING, ARCHITECTURAL EXPRESSION AND DETAILING ARE DESIGNED TO BE IN KEEPING WITH TRADITIONAL HOUSES OF THE AREA. ACCESS DESIGNED IN COMPLIANCE WITH PART M AND DMURS WITH OFF STREET CAR PARKING AND HOMEZONE. PUBLIC FOOTPATHS NEAR DWELLING

STREET FACADES SO THAT STREET IS "ACTIVATED" AND INTERESTING FOR

OPEN GREEN SPACE 03

1101 m²

OPEN GREEN SPACE 02

NEW STONE WALL (FORMED IN EXISTING STONEWORK RETAINED)-

MEASURED 90000 ALONG CARRAIGEWAY

PEDESTRIANS TO ENCOURAGE ACTIVE TRAVEL TO THE LOCAL VILLAGE.

EASTERN NEIGHBOUR'S ROADSIDE WALL. **GATE:** PROPOSED TIMBER PEDESTRIAN ACCESS GATE.

BOUNDARY TYPE B6: PROPOSED SELECTED STONE FACED

CREEN WALL WITH STONE CAPPING ON CONCRETE STRIP

FOUNDATION TO ENGINEERS SPECIFICATION AND DETAILS. 2m

BOUNDARY TYPE B8: PROPOSED TIMBER PALISADE FENCE MIN

EXISTING BOUNDARIES: EXISTING STONE WALL BOUNDARY TO

2000MM HIGH FOUNDATIONS TO ENGINEERS SPECIFICATION

BOUNDARY WALLS. EXISTING STONE WALL BOUNDARIES TO

NEIGHBOURING BUNGALOW ON EAST SIDE TO BE RETAINED.

WITH NEW PALISADE TIMBER FENCING. EXISTING BLOCKWORK

ENTRANCE- MAKING GOOD AT EXISTING PILLAR IN LINE WITH

GARDEN 0

EXISTING HEDGEGROW WITH POST & WIRE FENCE ALONG

EASTERN BOUNDARY TO BE RETAINED AND REINFORCED

BOUNDARY WALL TO SOUTH EAST CORNER OF SITE TO BE

PARTIALLY REMOVED TO ENSURE VISIBILITY AT NEW

HIGH TO PRIVATE GARDENS. NEW STONE ROADSIDE WALL &

BOUNDARY INFILL WALL HEIGHTS TO MATCH EXISTING.

FRONT (SOUTH ROADSIDE) OF SITE TO BE REMOVED-

NATURAL STONE TO BE RÉTAINED FOR RE-USE IN NEW

WEST AND NORTH OF SITE TO BE RETAINED. EXISTING

BLOCKWORK BOUNDARY WALLS SEPARATING SITE FROM

AND DETAILS.

GARDEN 04 GARDEN 05

106 m²

EXISTING NATIVE TREES TO BE RETAINED

GARDEN 06 GARDEN 07

OPEN GREEN SPACE 01

3007 m²

105 m²

NEW ESB SUB STATION

EXISTING HEDGEROW TO BE RETAINED

SURFACE FINISH S1: GRASS: GRASS SEEDED AREA: GRASS SELECTION & MAINTENANCE TO BE IN COMPLIANCE WITH RECOMMENDATIONS OF "ALL IRELAND POLLINATOR PLAN".

SURFACE FINISH S2: VEHICULAR ROADWAY: ASPHALT FINISH ON BASE LAYERS TO STRUCTURAL ENGINEERS SPECIFICATION AND DETAILS. FINISH COLOURS MAY BE VARIED TO SLOW

TRAFFIC AT PARKING AREAS SUBJECT TO DETAIL. SURFACE FINISH S3: HOME ZONE TURNING AREA: PERMEABLE PAVED FINISH AS PER S5. DIMENSIONS TO ALLOW TURNING

FOR FIRE APPLIANCE AS PER TGD B & SERVICE VEHICLE. **SURFACE FINISH S4: FOOTPATHS:** IN-SITU CONCRETE FOOTPATH ON BASE LAYERS TO STRUCTURAL ENGINEERS SPECIFICATION AND DETAILS. LESS THAN 1:20 FALLS TO PROVIDE UNIVERSAL ACCESS- WITH LANDINGS AT MAX RISE 500MM INTERVALS.

SURFACE FINISH S5: PARKING AREAS: SELECTED PERMEABLE PAVING ON BASE LAYERS TO STRUCTURAL ENGINEERS SPECIFICATION AND DETAILS. MIN 19 NO SPACES (INCLUDES 1 NO ACCESSIBLE AND 8 NO VISITORS)

SURFACE FINISH S6: PRIVACY -GRAVEL AREAS: SELECTED

NATURAL STONE GRAVEL AGGREGATE ON PROPRIETARY

GRAVEL STABILIZER ON GEO-TEXTILE MEMBRANE ON BASE TO STRUCTURAL ENGINEERS SPECIFICATION AND DETAILS. **SURFACE FINISH S7: ACCESS VERGE:** BUFFER ZONES BETWEEN PARKING AREAS AND PUBLIC FOOTPATHS WITH PROPRIETARY BONDED STONE AGGREGATE SURFACE FINISH

<u>SURFACE FINISH S8 : PRIVACY PLANTERS:</u> PLANTERS FORMED TO ENHANCE PRIVACY TO FRONTS OF NEW

SURFACE FINISH S9 : TRAFFIC CALMING: PAVED FINISH AS PER S5 ABOVE - TRAFFIC CALMING PROFILE TO STRUCTURAL ENGINEER'S DETAIL.

NEW OPEN SPACE TREE "ALL IRELAND POLLINATOR PLAN" FRIENDLY SPECIES

NEW ORNAMENTAL STREET TREE "ALL IRELAND POLLINATOR PLAN" FRIENDLY SPECIES **NEW NATIVE HEDGEROW**- "ALL IRELAND POLLINATOR

PLAN" FRIENDLY SPECIES NEW SHRUB PLANTING - "ALL IRELAND POLLINATOR PLAN" FRIENDLY SPECIES

TOTAL SITE AREA (m²)		10983 APPROX
AREA OF OPEN GREEN SPACE (m	2)	6196 APPROX

(90) 3 BED (6 PERSON) DORMER SCALE HOUSE TYPE

(90) 2 BED (4 PERSON) DORMER SCALE HOUSE TYPE

SCHEDULE

UNIT NUMBER

UNIT NUMBER

UNIT 03

UNIT 04

UNIT 05

UNIT 06

UNIT 07

UNIT 02

UNIT 08

HOUSE TYPE COMMENT

3 BED DORMER HOUSE TYPE TOTAL: 3

HOUSE TYPE COMMENT

2 BED DORMER HOUSE TYPE TOTAL: 5

DORMER-3B (6P) HANDED

DORMER-2B (4P) HANDED

DORMER-2B (4P) HANDED

DORMER-2B (4P) HANDED

DORMER-3B (6P)

DORMER-2B (4P)

DORMER-2B (4P)

DORMER-3B (6P) GABLE-ENTRANCE UNIT 01

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EXISTING STONE WALL ALONG ROADSIDE AND PART ALONG WESTER BOUNDARY REMOVED TO ENSURE VISIBILITY TO WEST OF ENTRANCE. TO BE MADE GOOD AT JUNCTION OF NEW ROADSIDE WALL & EXISTING


BOUNDARY WALL. EXISTING STONEWORK TO BE RETAINED FOR RE-USE IN NEW ROADSIDE WALL

LEVELS-BOUNDARY-TREATMENTS PLAN-OVERVIEW

NEW STONE WALL (FORMED IN EXISTING STONEWORK RETAINED)-HEIGHT TO MATCH EXISTING

SITE LAYOUT PLAN-OVERVIEW SCALE 1:500 NOTE: 1:500 @ A1 1:1000 @ A3

STATUS KEY An Board Plaeanale Submission

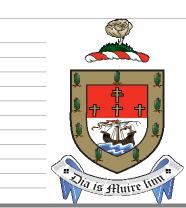

ARCHITECTS DEPARTMENT MAYO COUNTY COUNCIL

SITE NOTICE LOCATION-

SITE NOTICE LOCATION



APPROX 21450

Purpose of Iss	ABP APP	LICATION
Project No:	Project Title: Housing	Dwg Type
Δ 586	Housing	00


PART OF EXISTING WALL REMOVED TO ENSURE

VISIBILITY TO EAST OF ENTRANCE- MAKING GOOD

AT EXISTING PILLAR

SITE NOTICE LOCATION

Project No:	Project 7		Dwg Type	Status:	
A_586	Housi CROS	ng SS WEST, CO. MAYO	90	A1	
Drawing Title:	_	LAYOUT PLAN ELS-BOUNDARY	Drawing No. 5201	Revision:	
	TREA	TMENTS-OVERVIEW	Scale:	First Issue:	
Drawn By:	cm/mw	No Orig - Cat - Lvl - Type - Role - No Status	1:500	JULY 2021	
Checked By:	СМ	A_586 - MCC - 90 - XX - DR - A - 5201 - A1	1.500	JULT 2021	

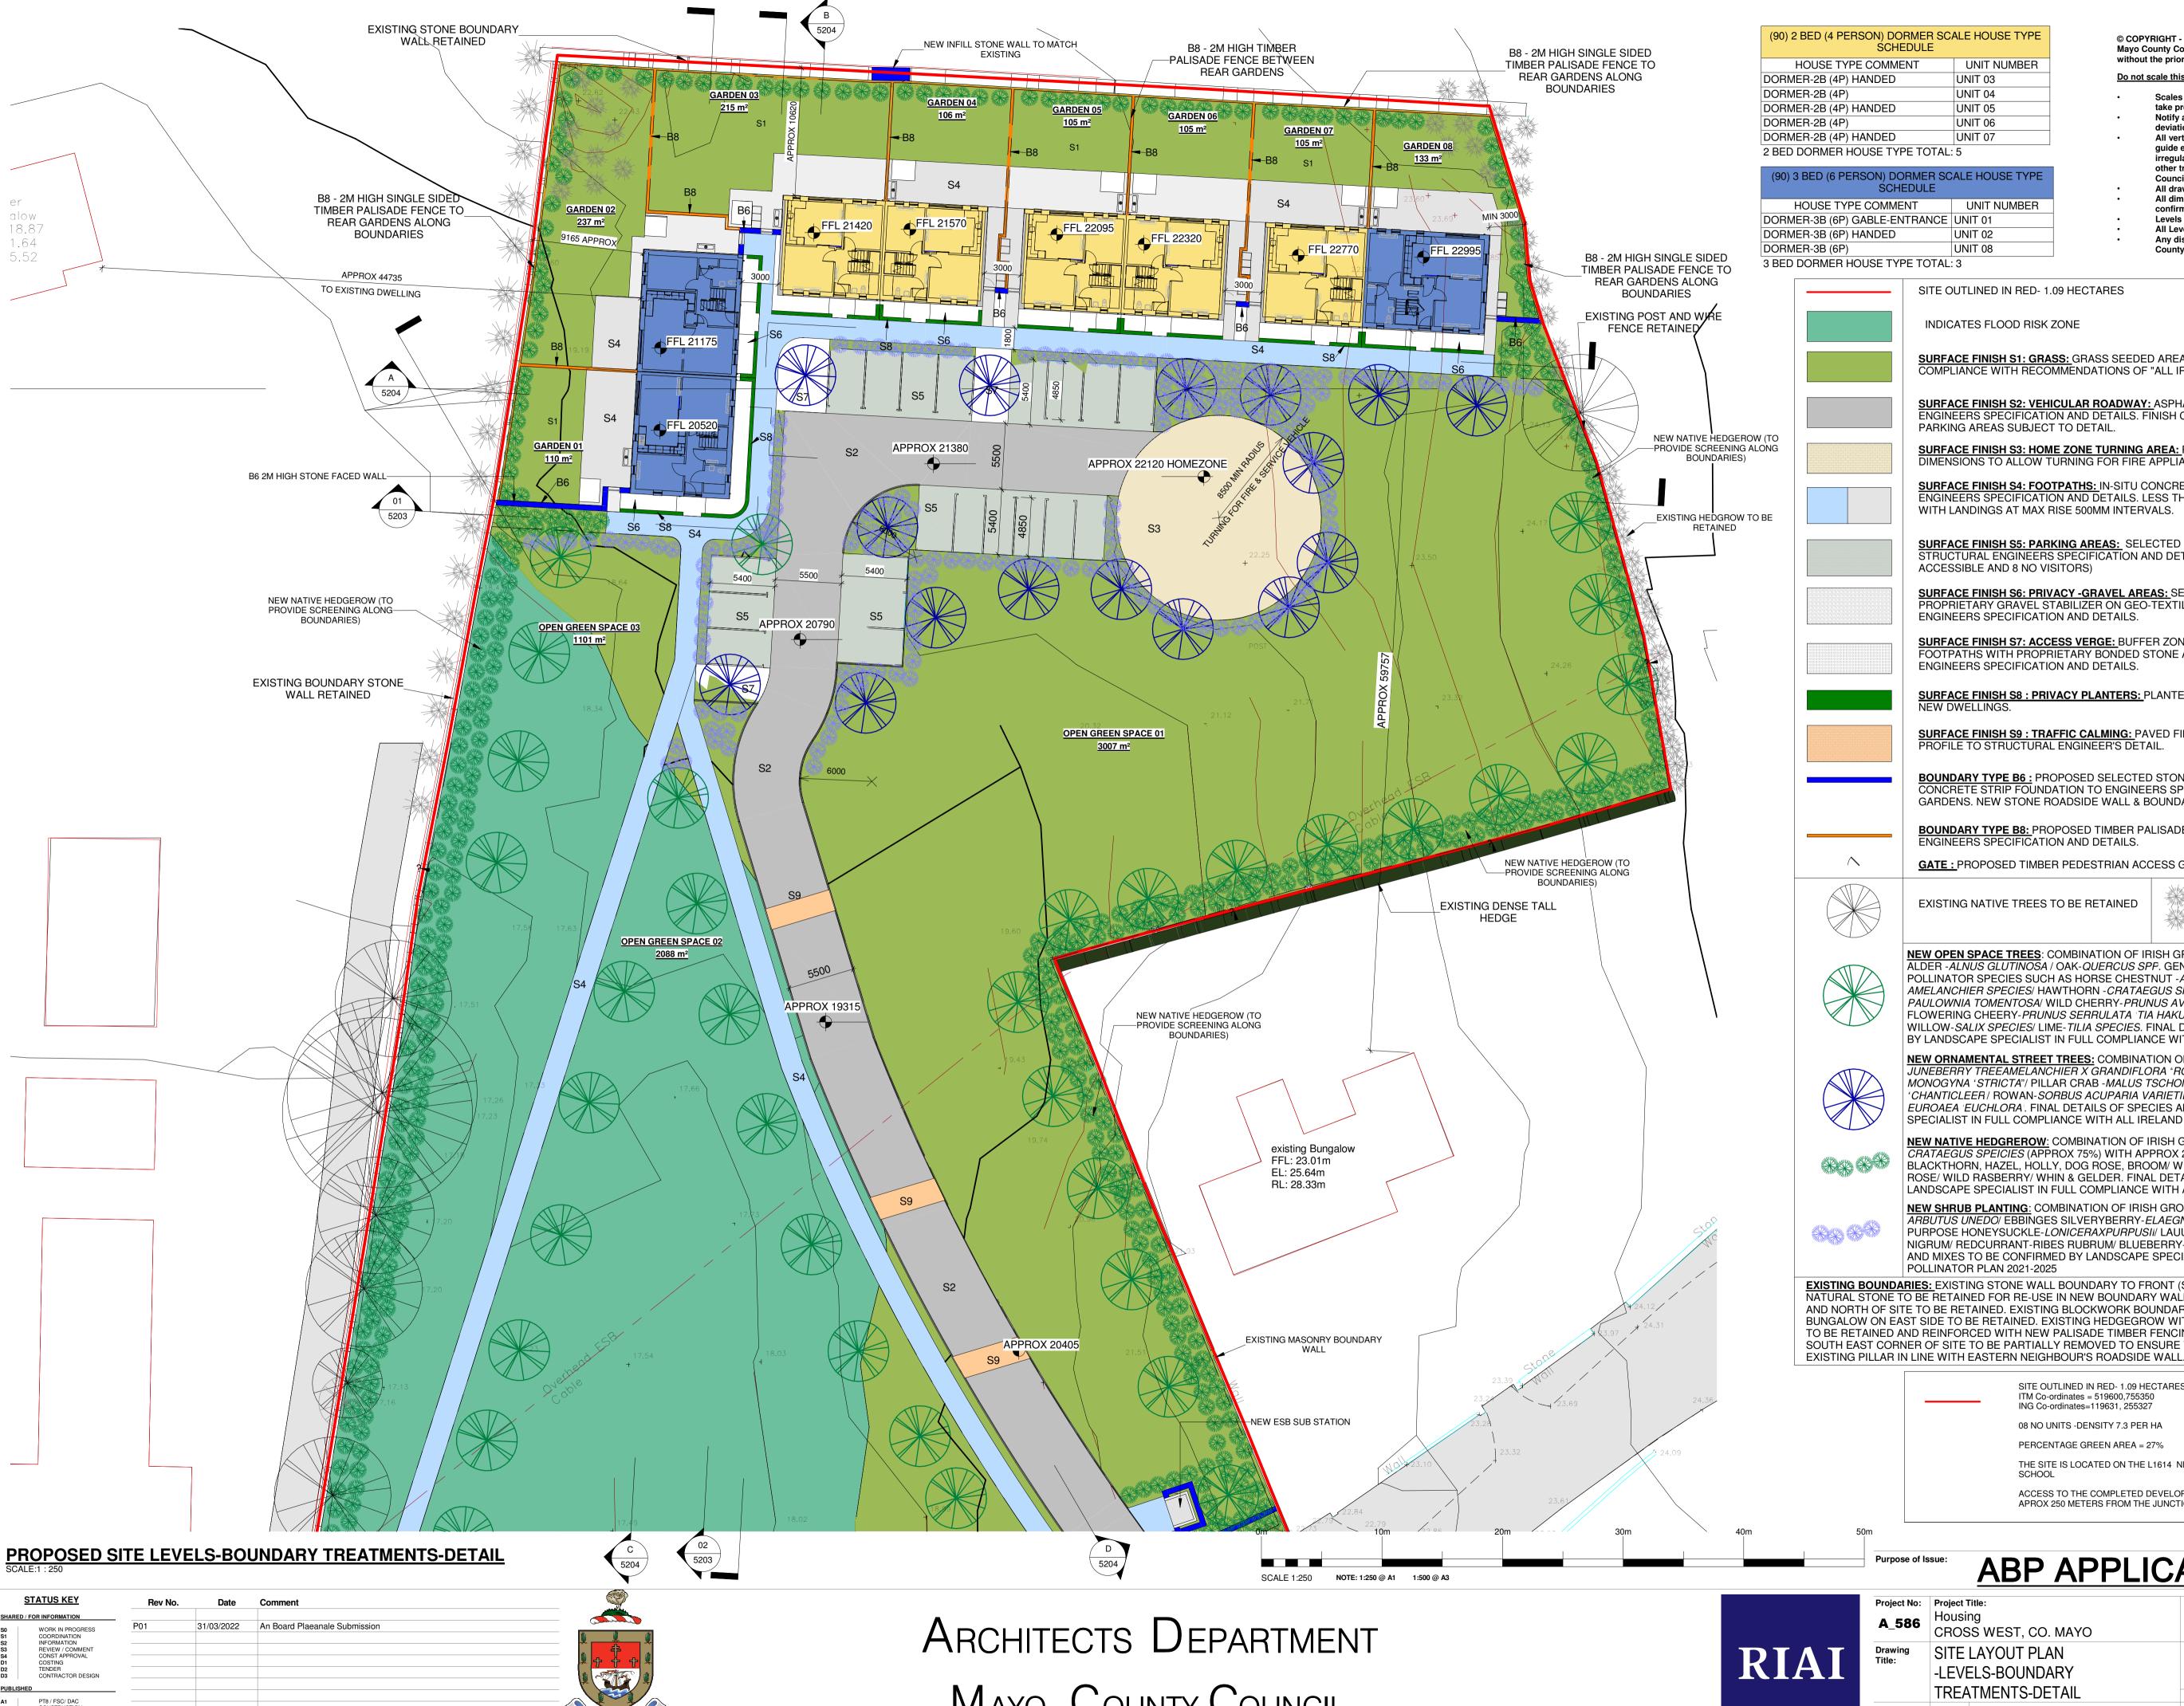

(90) 2 BED (4 PERSON) DORMER SCALE HOUSE TYPE UNIT NUMBER

HOUSE TYPE COMMENT UNIT 03 UNIT 04 UNIT 05 UNIT 06 UNIT 07

(90) 3 BED (6 PERSON) DORMER SCALE HOUSE TYPE HOUSE TYPE COMMENT UNIT NUMBER DORMER-3B (6P) GABLE-ENTRANCE UNIT 01

UNIT 08

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SITE OUTLINED IN RED- 1.09 HECTARES

INDICATES FLOOD RISK ZONE

SURFACE FINISH S1: GRASS: GRASS SEEDED AREA: GRASS SELECTION & MAINTENANCE TO BE IN COMPLIANCE WITH RECOMMENDATIONS OF "ALL IRELAND POLLINATOR PLAN".

<u>SURFACE FINISH S2: VEHICULAR ROADWAY: ASPHALT FINISH ON BASE LAYERS TO STRUCTURAL</u> ENGINEERS SPECIFICATION AND DETAILS. FINISH COLOURS MAY BE VARIED TO SLOW TRAFFIC AT PARKING AREAS SUBJECT TO DETAIL.

SURFACE FINISH S3: HOME ZONE TURNING AREA: PERMEABLE PAVED FINISH AS PER S5. DIMENSIONS TO ALLOW TURNING FOR FIRE APPLIANCE AS PER TGD B & SERVICE VEHICLE.

<u>SURFACE FINISH S4: FOOTPATHS:</u> IN-SITU CONCRETE FOOTPATH ON BASE LAYERS TO STRUCTURAL ENGINEERS SPECIFICATION AND DETAILS. LESS THAN 1:20 FALLS TO PROVIDE UNIVERSAL ACCESS-WITH LANDINGS AT MAX RISE 500MM INTERVALS.

SURFACE FINISH S5: PARKING AREAS: SELECTED PERMEABLE PAVING ON BASE LAYERS TO STRUCTURAL ENGINEERS SPECIFICATION AND DETAILS. MIN 19 NO SPACES (INCLUDES 1 NO ACCESSIBLE AND 8 NO VISITORS)

SURFACE FINISH S6: PRIVACY -GRAVEL AREAS: SELECTED NATURAL STONE GRAVEL AGGREGATE ON PROPRIETARY GRAVEL STABILIZER ON GEO-TEXTILE MEMBRANE ON BASE TO STRUCTURAL ENGINEERS SPECIFICATION AND DETAILS.

SURFACE FINISH S7: ACCESS VERGE: BUFFER ZONES BETWEEN VEHICULAR AREAS AND PUBLIC FOOTPATHS WITH PROPRIETARY BONDED STONE AGGREGATE SURFACE FINISH TO STRUCTURAL ENGINEERS SPECIFICATION AND DETAILS.

SURFACE FINISH S8 : PRIVACY PLANTERS: PLANTERS FORMED TO ENHANCE PRIVACY TO FRONTS OF

SURFACE FINISH S9: TRAFFIC CALMING: PAVED FINISH AS PER S5 ABOVE - TRAFFIC CALMING PROFILE TO STRUCTURAL ENGINEER'S DETAIL.

BOUNDARY TYPE B6: PROPOSED SELECTED STONE FACED SCREEN WALL WITH STONE CAPPING ON CONCRETE STRIP FOUNDATION TO ENGINEERS SPECIFICATION AND DETAILS. 2m HIGH TO PRIVATE GARDENS. NEW STONE ROADSIDE WALL & BOUNDARY INFILL WALL HEIGHTS TO MATCH EXISTING.

BOUNDARY TYPE B8: PROPOSED TIMBER PALISADE FENCE MIN 2000MM HIGH FOUNDATIONS TO ENGINEERS SPECIFICATION AND DETAILS.

GATE: PROPOSED TIMBER PEDESTRIAN ACCESS GATE.

EXISTING NATIVE TREES TO BE RETAINED



NEW OPEN SPACE TREES: COMBINATION OF IRISH GROWN SPECIES SUCH AS BIRCH-BETULA SPPI ALDER -ALNUS GLUTINOSA / OAK-QUERCUS SPP. GENERALLY INTERPLANTED WITH MIX OF SELECTED POLLINATOR SPECIES SUCH AS HORSE CHESTNUT -AESULUS HIPPCASTANUM/ JUNEBERRY AMELANCHIER SPECIES/ HAWTHORN - CRATAEGUS SPECIES/ APPLE-MULUS SPECIES/ FOXGLOVE TREE PAULOWNIA TOMENTOSA/ WILD CHERRY-PRUNUS AVIUM/ BIRD CHERRY PRUNUS PADUS /JAPENESE

BY LANDSCAPE SPECIALIST IN FULL COMPLIANCE WITH ALL IRELAND POLLINATOR PLAN 2021-2025 **NEW ORNAMENTAL STREET TREES:** COMBINATION OF IRISH GROWN NATIVE SPECIES SUCH AS JUNEBERRY TREEAMELANCHIER X GRANDIFLORA "ROBIN HILL"/ UPRIGHT HAWTHORN -CRATAGUS MONOGYNA 'STRICTA"/ PILLAR CRAB -MALUS TSCHONSKII/ CARRERY PEAR -PYRUS ACLLERYANA *CHANTICLEER / ROWAN-SORBUS ACUPARIA VARIETIES / LIME -TILIA CORDATA 'GREENSPIRE / TILIA X EUROAEA EUCHLORA. FINAL DETAILS OF SPECIES AND MIXES TO BE CONFIRMED BY LANDSCAPE



SPECIALIST IN FULL COMPLIANCE WITH ALL IRELAND POLLINATOR PLAN 2021-2025 **NEW NATIVE HEDGREROW:** COMBINATION OF IRISH GROWN NATIVE SPECIES SUCH AS HAWTHORN -CRATAEGUS SPEICIES (APPROX 75%) WITH APPROX 25% MIX OF OTHER SPECIES SUCH AS WILLOW, BLACKTHORN, HAZEL, HOLLY, DOG ROSE, BROOM/ WILD CHEERY/ CRAB APPLE/ HONEYSUCKLE/ WILD ROSE/ WILD RASBERRY/ WHIN & GELDER. FINAL DETAILS OF SPECIES AND MIXES TO BE CONFIRMED BY

LANDSCAPE SPECIALIST IN FULL COMPLIANCE WITH ALL IRELAND POLLINATOR PLAN 2021-2025

FLOWERING CHEERY-PRUNUS SERRULATA TIA HAKU/ PEAR-PYRUS SPECIES/ ROWANSORBUS SPECIES/

WILLOW-SALIX SPECIES/ LIME-TILIA SPECIES. FINAL DETAILS OF SPECIES AND MIXES TO BE CONFIRMED

NEW SHRUB PLANTING: COMBINATION OF IRISH GROWN NATIVE SPECIES SUCH AS STRAWBERRY TREE ARBUTUS UNEDO/ EBBINGES SILVERYBERRY-ELAEGNUS X EBBINGIE/ SILVERTHORN-ELAEGNUS PUNGENS/ PURPOSE HONEYSUCKLE-LONICERAXPURPUSII/ LAUUSTINUS-VIBURNUM TINUS/ BLACKCURRANT-RIBES NIGRUM/ REDCURRANT-RIBES RUBRUM/ BLUEBERRY-VACCINIUM CORYMOSUM.FINAL DETAILS OF SPECIES AND MIXES TO BE CONFIRMED BY LANDSCAPE SPECIALIST IN FULL COMPLIANCE WITH ALL IRELAND POLLINATOR PLAN 2021-2025

EXISTING BOUNDARIES: EXISTING STONE WALL BOUNDARY TO FRONT (SOUTH ROADSIDE) OF SITE TO BE REMOVED-NATURAL STONE TO BE RETAINED FOR RE-USE IN NEW BOUNDARY WALLS. EXISTING STONE WALL BOUNDARIES TO WEST BUNGALOW ON EAST SIDE TO BE RETAINED. EXISTING HEDGEGROW WITH POST & WIRE FENCE ALONG EASTERN BOUNDARY TO BE RETAINED AND REINFORCED WITH NEW PALISADE TIMBER FENCING. EXISTING BLOCKWORK BOUNDARY WALL TO SOUTH EAST CORNER OF SITE TO BE PARTIALLY REMOVED TO ENSURE VISIBILITY AT NEW ENTRANCE- MAKING GOOD AT




SITE OUTLINED IN RED- 1.09 HECTARES ITM Co-ordinates = 519600,755350 ING Co-ordinates=119631, 255327 08 NO UNITS -DENSITY 7.3 PER HA

PERCENTAGE GREEN AREA = 27%

THE SITE IS LOCATED ON THE L1614 NEAR TO CROSS NATIONAL

ACCESS TO THE COMPLETED DEVELOPMENT TO BE VIA THE L1614 APROX 250 METERS FROM THE JUNCTION WITH THE R334

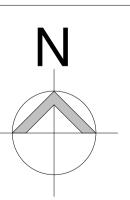

ABP APPLICATION

Project No:	Project 7		Dwg Type	Status:
A_586	Housi CROS	ng SS WEST, CO. MAYO	90	A1
Drawing Title:	-LEVI	LAYOUT PLAN ELS-BOUNDARY	Drawing No. 5202	Revision:
	TREA	TMENTS-DETAIL	Scale:	First Issue
Drawn By:	cm/mw	No Orig - Cat - Lvl - Type - Role - No Status	As indicated	JULY 202
Checked By	СМ	A 586 - MCC - 90 - XX - DR - A - 5202 - A1	As indicated	JULY 202



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- All vertical dimensions shall be taken from a "bench mark" or other similar guide established prior to the start of construction. High points, low points, irregularities in floor slab which could affect fabrication / installation, work of other trades or vendors shall be brought to the attention of Mayo County Council Architects immediately.
- All drawings are to be read in conjunction with other consultant's drawings All dimensions, unless otherwise stated, are given in millimetres and must be confirmed and checked by the Contractor on site. Levels are generally given in metres from a specified datum.
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A1

Revision: P01

First Issue:

Drawing No.

5206

As indicated

CROSS WEST, CO. MAYO


LAYOUT

PROPOSED SITE SERVICES

Drawn By: cm/mw No. - Orig - Cat - Lvl - Type - Role - No. - Status

Checked By: CM A_586 - MCC - 90 - XX - DR - A - 5206 - A1

RIAI

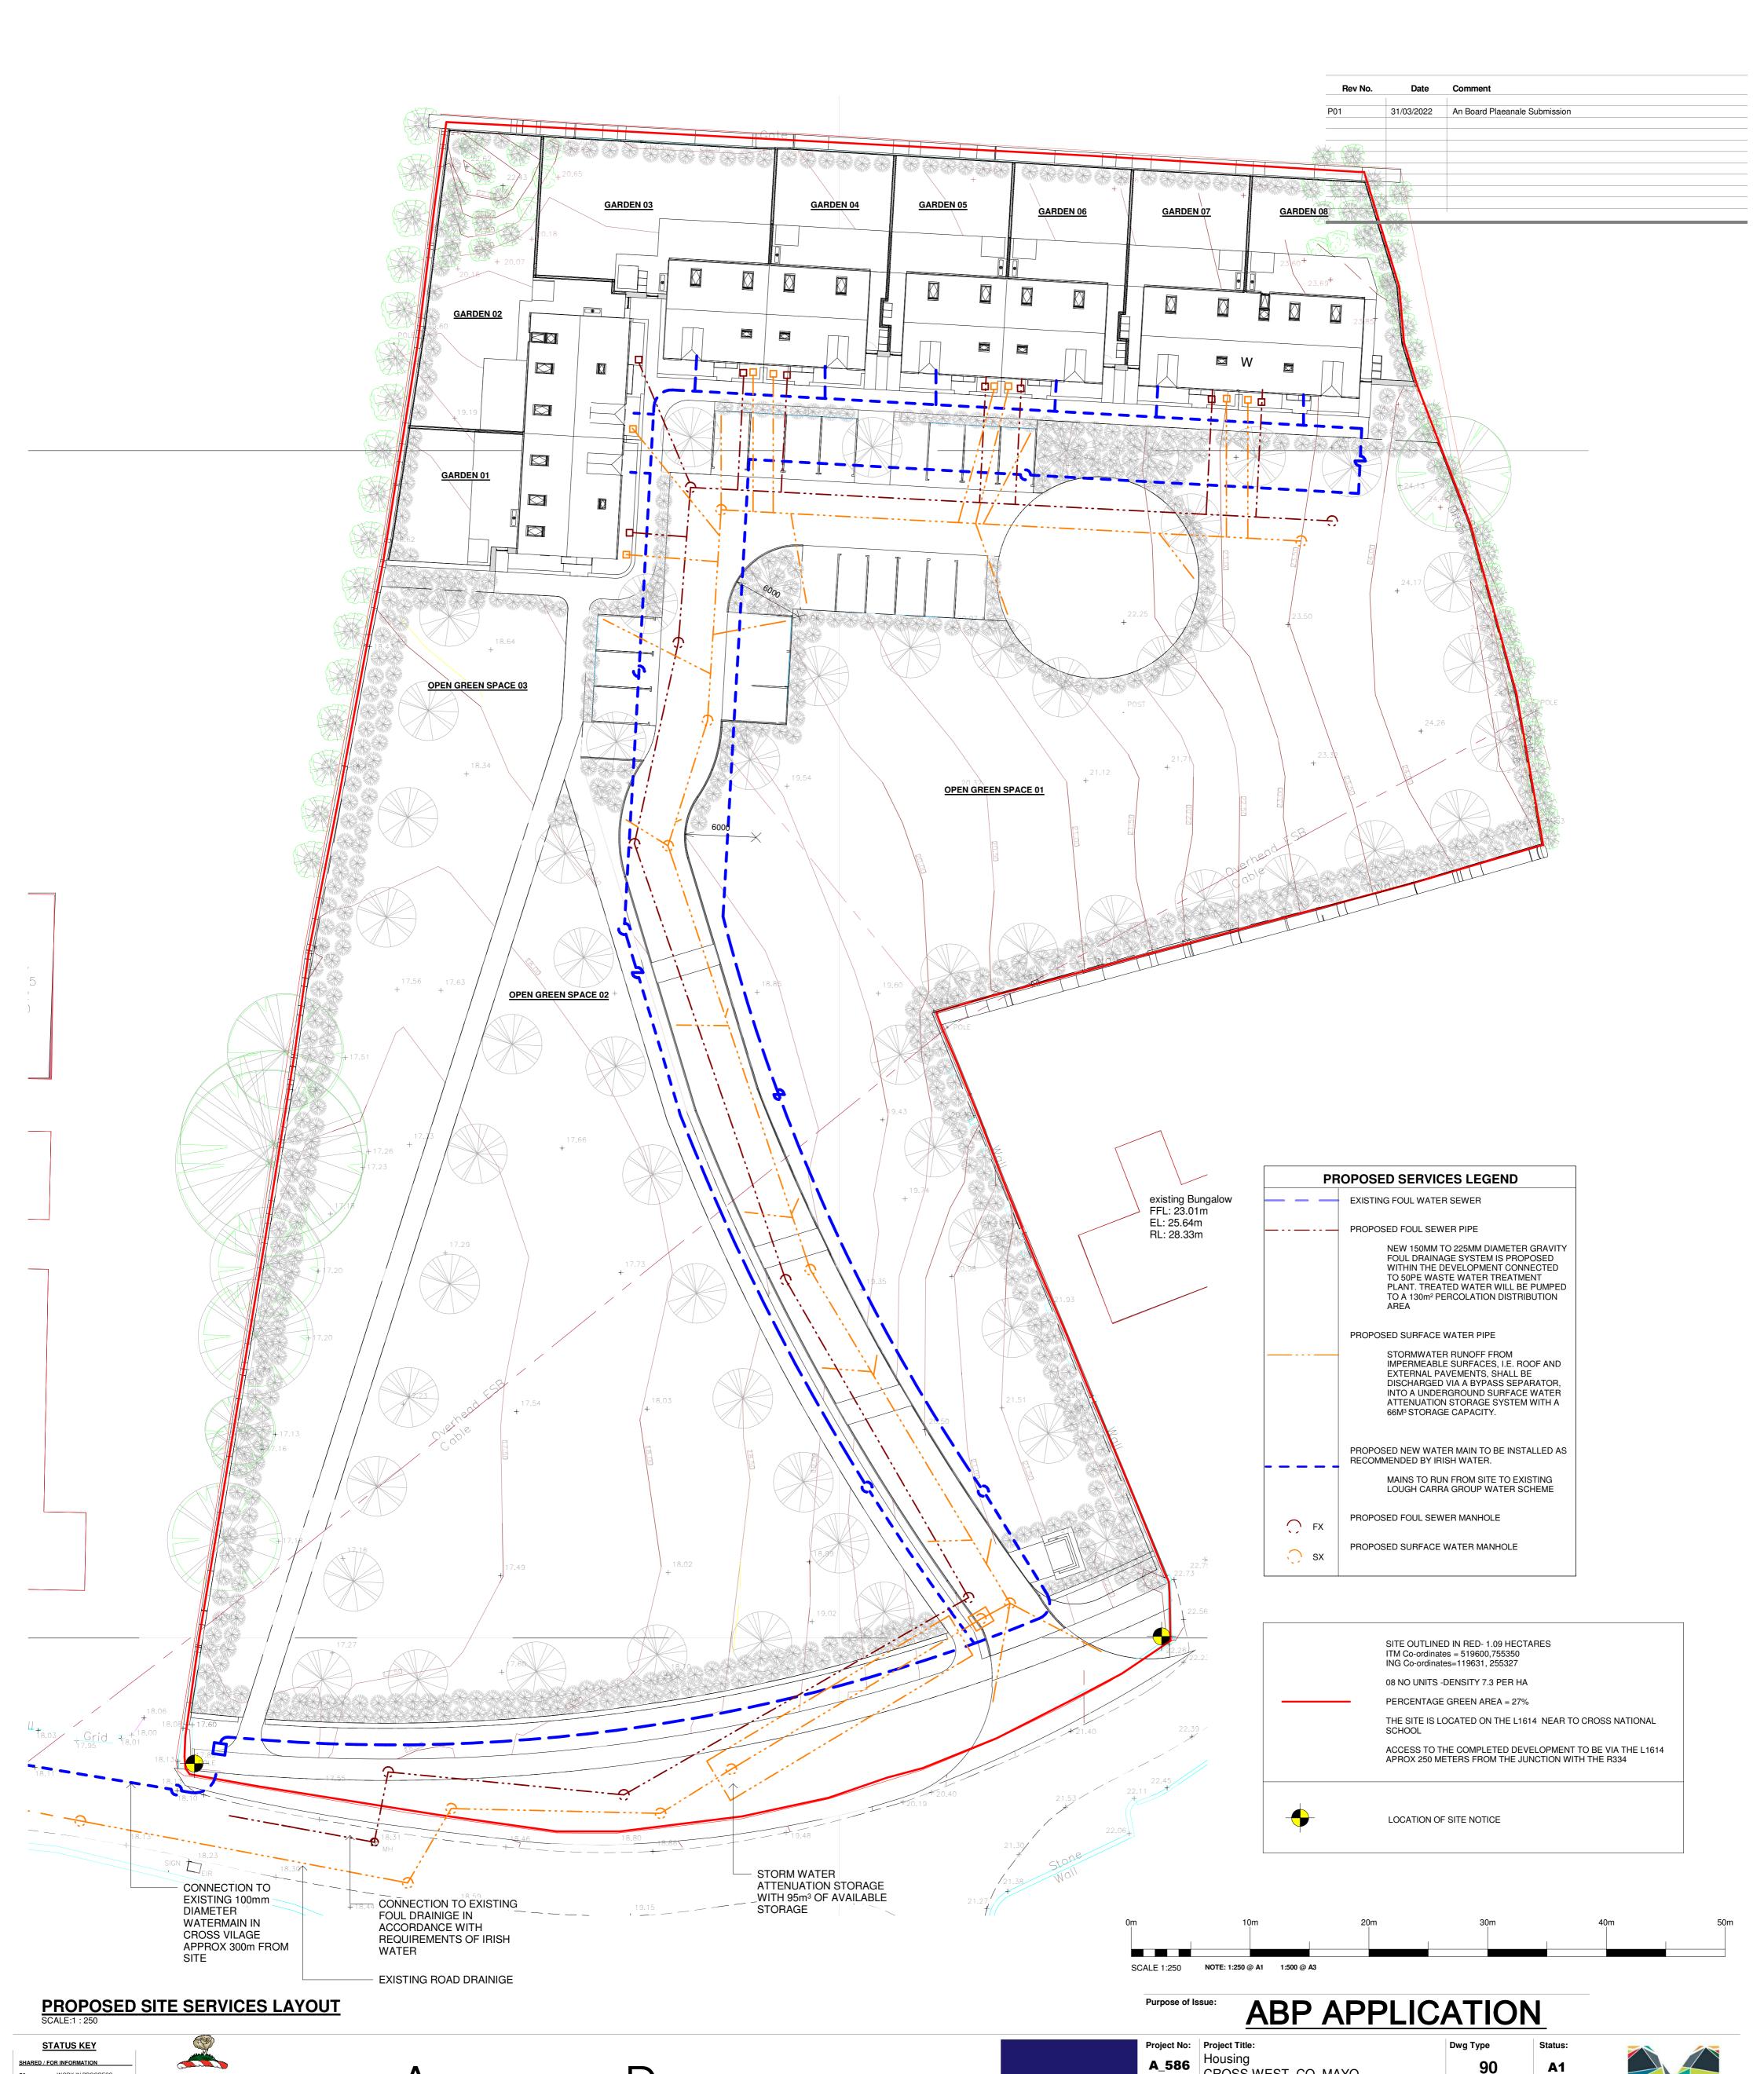


ARCHITECTS DEPARTMENT

MAYO COUNTY COUNCIL

WORK IN PROGRESS COORDINATION INFORMATION REVIEW / COMMENT CONST APPROVAL COSTING TENDER CONTRACTOR DESIGN

 $C: \label{lem:constant} C: \label{lem:constant} C: \label{lem:constant} WEST \ (A3t) Drawings \ REVIT \ A586-MCC-XX-90-M3-A-0000.rvt$

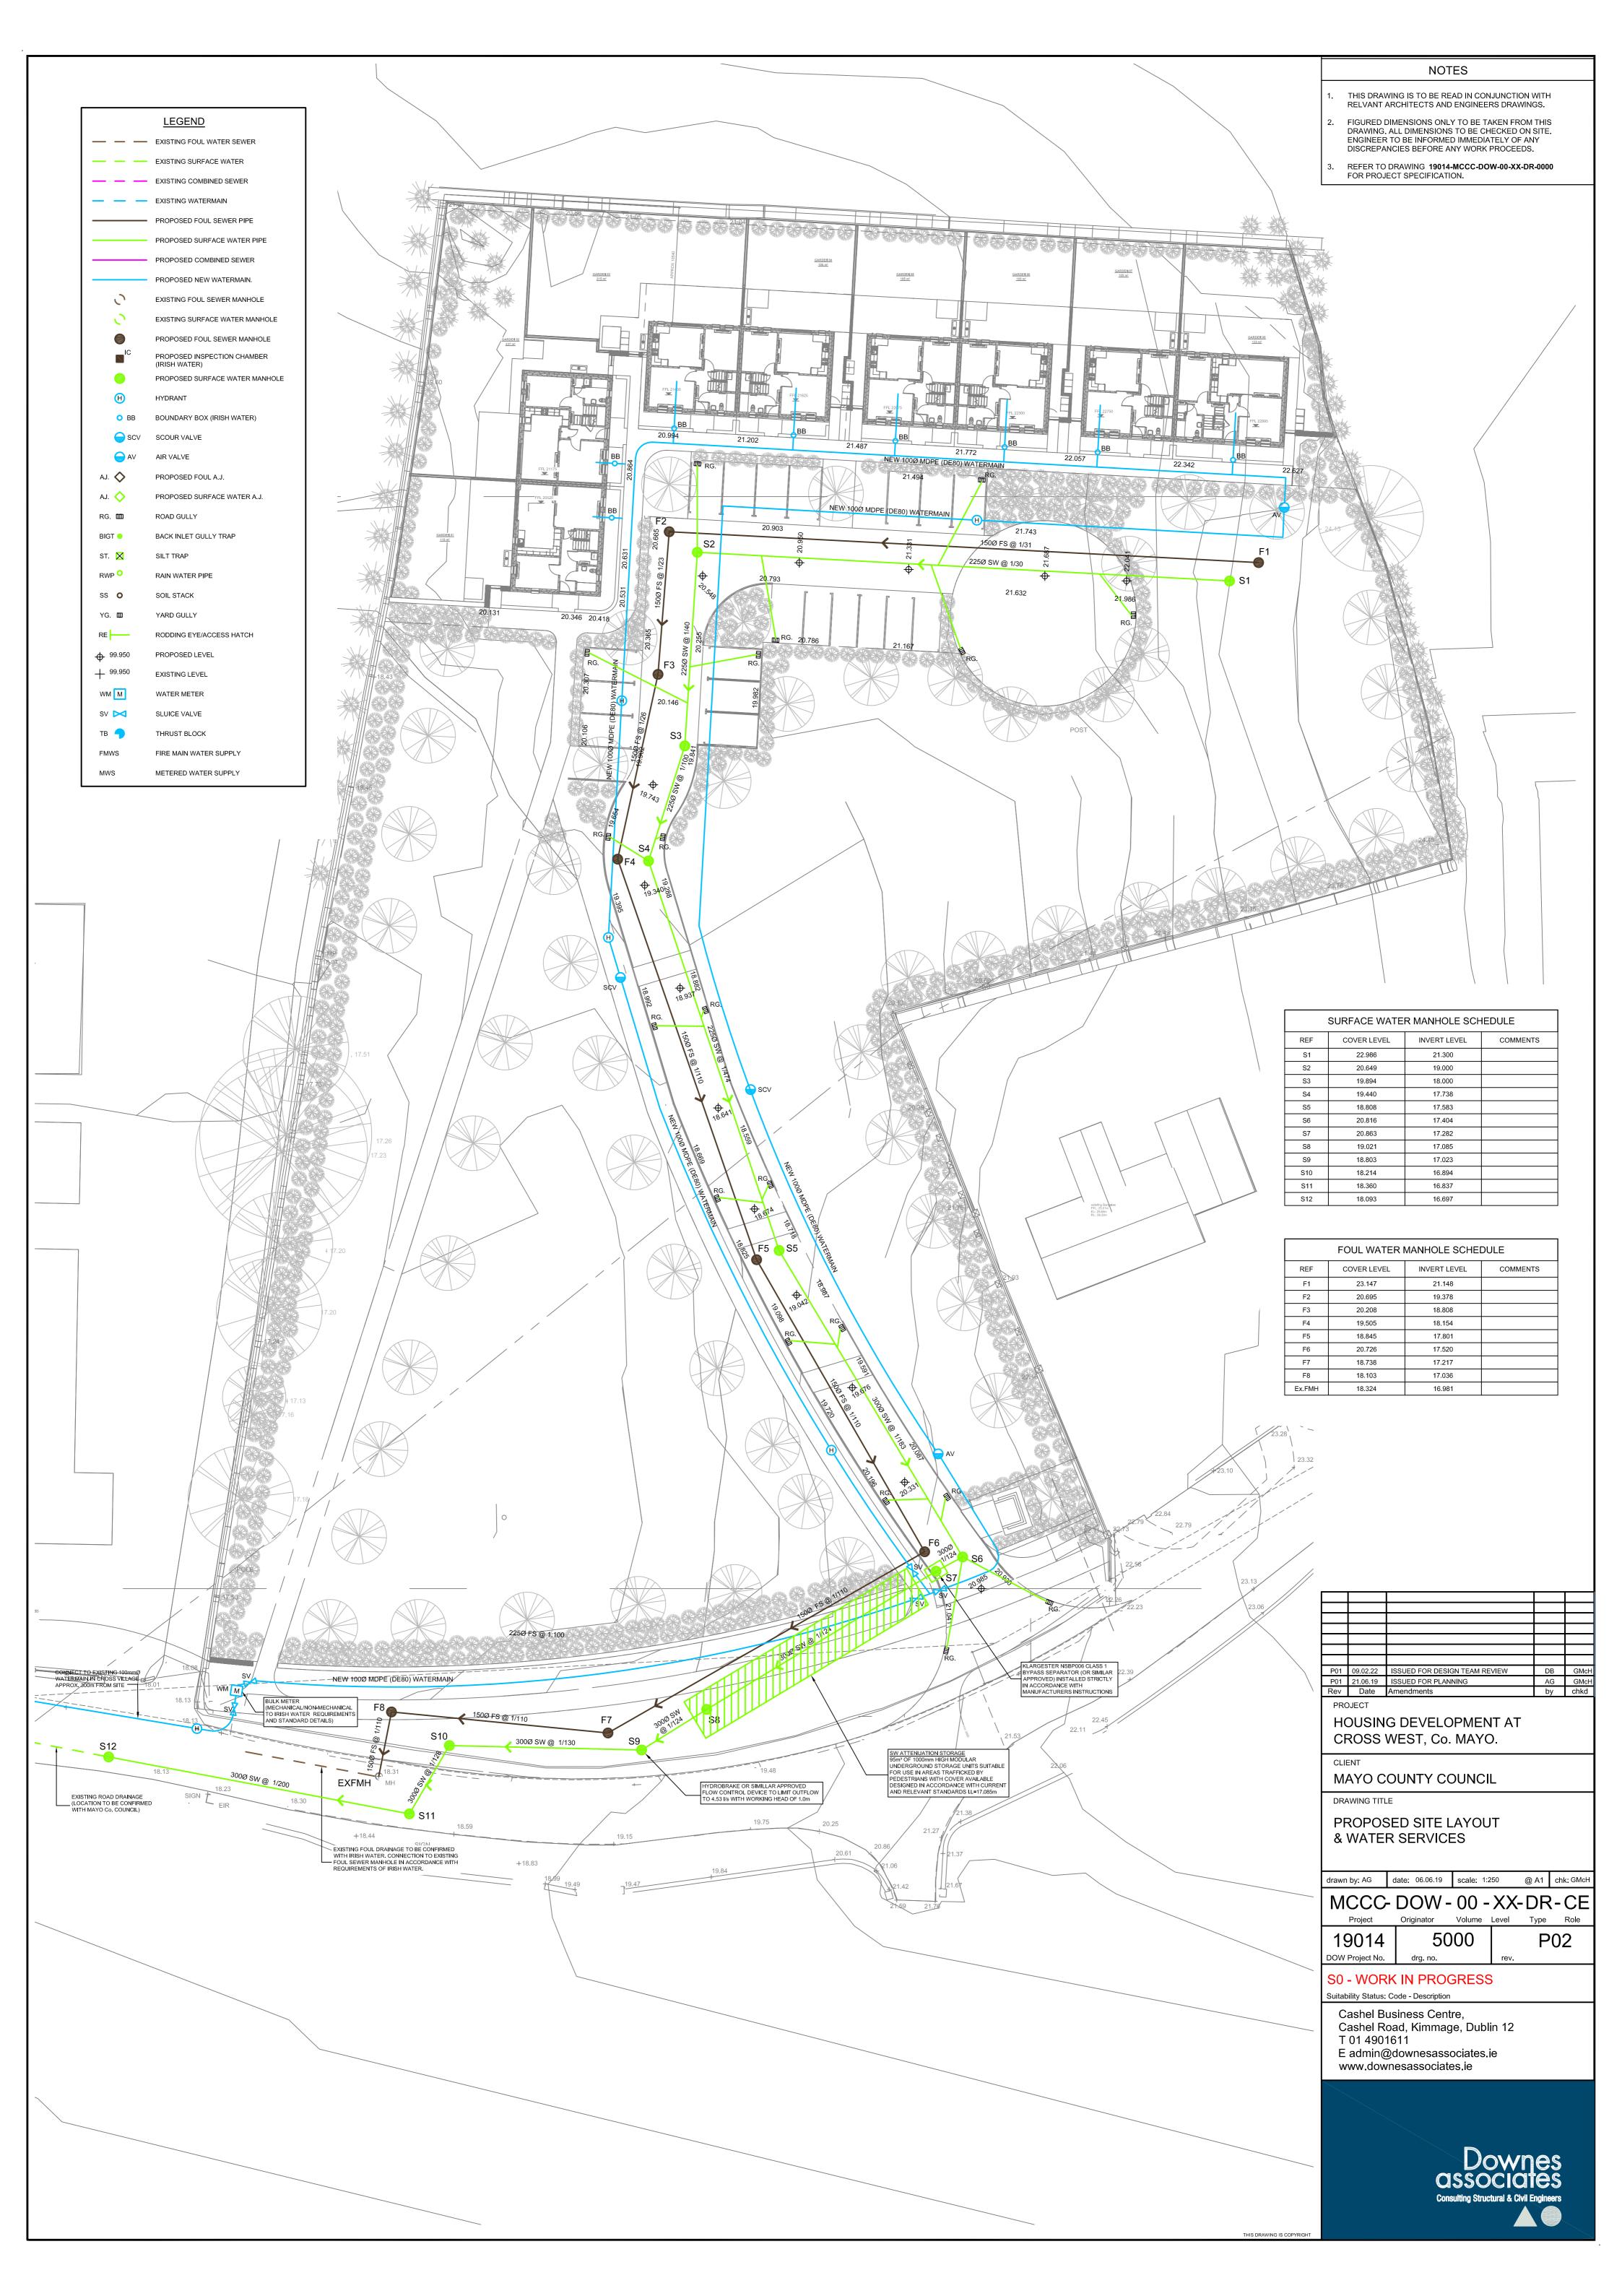



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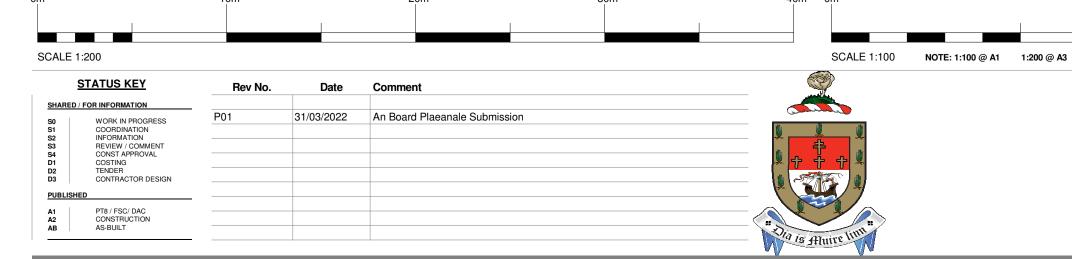
STREET ELEVATION-FACING UNITS 01 TO 08- DETAIL SCALE: 1:100



STREET ELEVATION- FACING UNITS 01-02-OVERVIEW SCALE: 1:200



STREET ELEVATION- FACING UNITS 01-02-DETAIL SCALE: 1:100



ARCHITECTS DEPARTMENT MAYO COUNTY COUNCIL

PROPOSAL:	CONSTRUCTION 0F 08 NO. DWELLINGS COMPRISING OF 05 NO. 2 BEDROOMED DORMER SCALE TWO STOREY HOUSES AND 3 NO. 3 BEDROOMED DORMER SCALE TWO STOREY HOUSES IN A SEMI-DETACHED ARRANGEMENT. SCALE, MASSING, ARCHITECTURAL EXPRESSION AND DETAILING ARE DESIGNED TO BE IN KEEPING WITH TRADITIONAL HOUSES OF THE AREA. ACCESS DESIGNED IN COMPLIANCE WITH PART M AND DMURS WITH OFF STREET CAR PARKING AND HOMEZONE. PUBLIC FOOTPATHS NEAR DWELLING STREET FACADES SO THAT STREET IS "ACTIVATED" AND INTERESTING FOR PEDESTRIANS TO ENCOURAGE ACTIVE TRAVEL TO THE LOCAL VILLAGE.
MATERIALS: (EXTERNAL)	EXTERNAL ROOF FINISH: PITCHED ROOFS FINISHED WITH SLATE BLUE BLACK IN COLOUR. EXTERNAL WINDOWS & DOORS: TIMBER ALU CLAD FRAMES WITH HIGHLY EFFICIENT GLAZING (MAX 0.8W/MK) -FINISHED IN SELECTED COLOURS TO DETAIL. EXTERNAL WALLS: GENERALLY MASONRY WITH RENDERED FINISH PAINTED TO SELECTED NEUTRAL COLOUR DORMER WINDOW: SELECTED GREY STANDING SEAM FINISH TO FEATURE DORMER WINDOW AND PORCH CANOP FASCIA & SOFFIT TO MATCH RAINWATER PRODUCTS. PRE-CAST CONCRETE CILLS TO WINDOWS CONCRETE FOOTPATHS TO PERIMETER-BRUSH FINISH FLUSH DOOR THRESHOLD TO FRONT DOOR, WITH DRAINAGE CHANNEL TO ENTRANCE

ABP APPLICATION

RIA

Project No:	Project		Dwg Type	Status:	
A_586	Housi CROS	ng SS WEST, CO. MAYO	90	A1	
Drawing Title:	PROF	POSED SITE ELEVATIONS	Drawing No. 5203	Revision:	
			Scale:	First Issue	
Drawn By:	cm/mw	No Orig - Cat - Lvl - Type - Role - No Status	As indicated	JULY 2021	
Checked By:	СМ	A 586 - MCC - 90 - XX - DR - A - 5203 - A1	As indicated	JULY 2021	





CONSTRUCTION 0F 08 NO. DWELLINGS COMPRISING OF 05 NO. 2 BEDROOMED DORMER SCALE TWO STOREY HOUSES AND 3 NO. 3 BEDROOMED DORMER SCALE TWO STOREY HOUSES IN A SEMI-DETACHED ARRANGEMENT. SCALE, MASSING, ARCHITECTURAL EXPRESSION AND DETAILING ARE DESIGNED TO BE IN KEEPING WITH TRADITIONAL HOUSES OF THE AREA. PROPOSAL: ACCESS DESIGNED IN COMPLIANCE WITH PART M AND DMURS WITH OFF STREET CAR PARKING AND HOMEZONE. PUBLIC FOOTPATHS NEAR DWELLING STREET FACADES SO THAT STREET IS "ACTIVATED" AND INTERESTING FOR PEDESTRIANS TO ENCOURAGE ACTIVE TRAVEL TO THE LOCAL VILLAGE.

MATERIALS: (EXTERNAL)

EXTERNAL ROOF FINISH: PITCHED ROOFS FINISHED WITH SLATE BLUE BLACK IN COLOUR.

EXTERNAL WINDOWS & DOORS: TIMBER ALU CLAD FRAMES WITH HIGHLY EFFICIENT GLAZING (MAX 0.8W/MK) -FINISHED IN SELECTED COLOURS TO DETAIL. EXTERNAL WALLS: GENERALLY MASONRY WITH RENDERED FINISH PAINTED TO SELECTED NEUTRAL COLOUR **DORMER WINDOW: SELECTED GREY STANDING SEAM**

FASCIA & SOFFIT TO MATCH RAINWATER PRODUCTS.

FINISH TO FEATURE DORMER WINDOW AND PORCH CANOP

PRE-CAST CONCRETE CILLS TO WINDOWS

FLUSH DOOR THRESHOLD TO FRONT DOOR, WITH DRAINAGE CHANNEL TO ENTRANCE


CONCRETE FOOTPATHS TO PERIMETER-BRUSH FINISH

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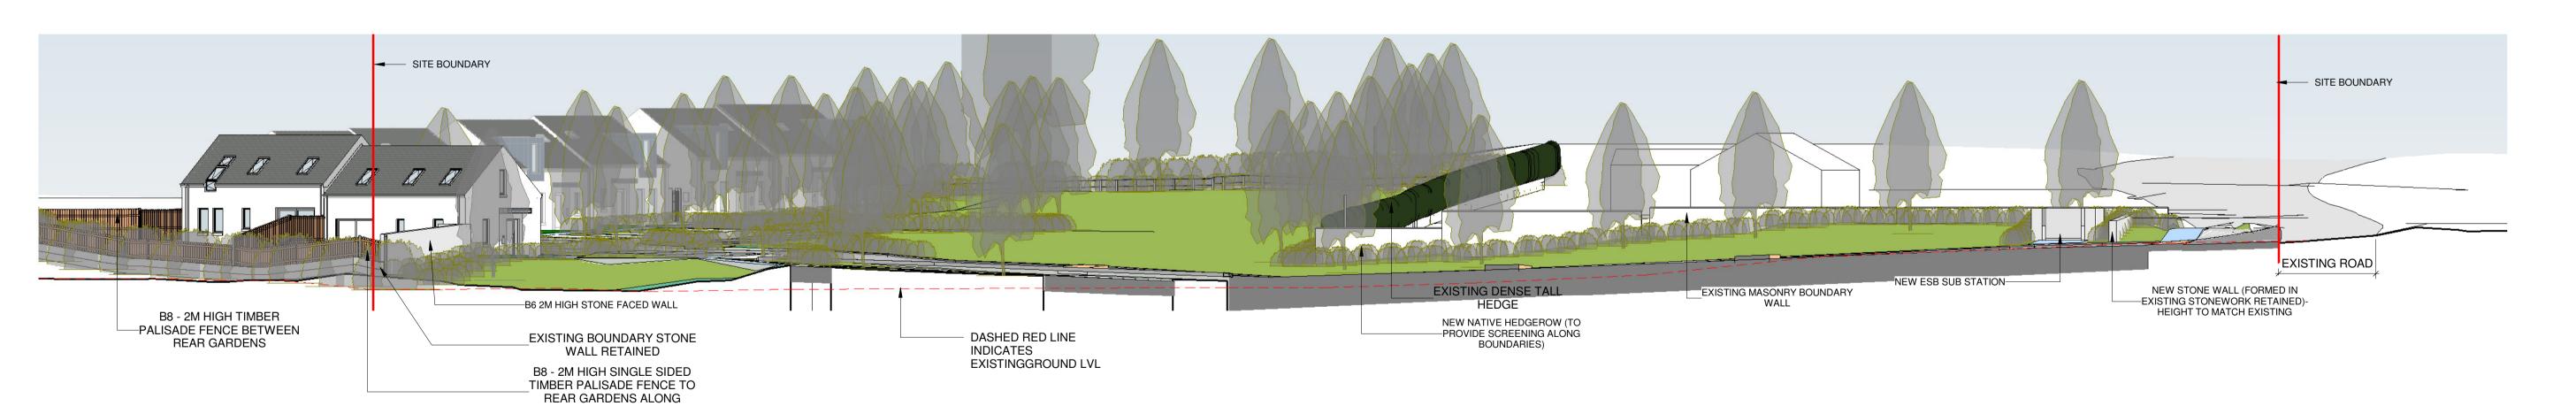
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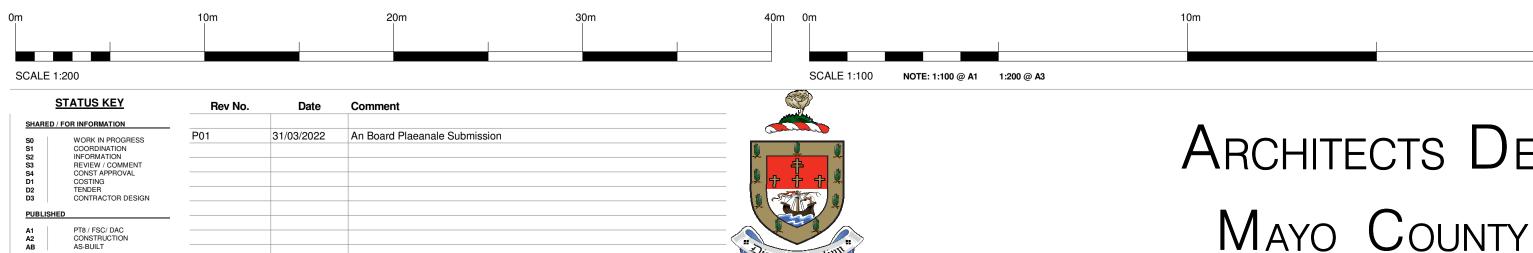


SITE SECTION B-THRU UNIT 3 -FACING WEST



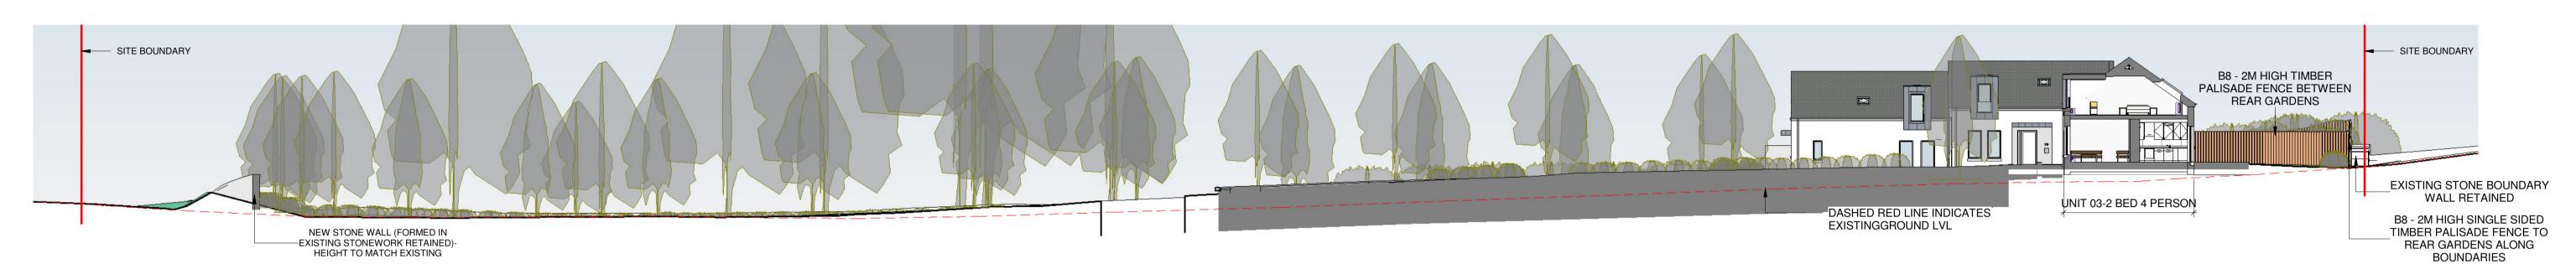

SITE SECTION D- THRU ENTRANCE ROADWAY FACING NORTH EAST



BOUNDARIES


ARCHITECTS DEPARTMENT MAYO COUNTY COUNCIL


ABP APPLICATION


RIAI

Drawn By: Checked By:	cm/mw CM	No Orig - Cat - Lvl - Type - Role - No Status A 586 - MCC - 90 - XX - DR - A - 5204 - A1	1:200	JULY 2021			
D	,		Scale:	First Issue			
Drawing Title:	PRO	POSED SITE SECTIONS	Drawing No. 5204	Revision:			
A_586	Housi CROS	ng SS WEST, CO. MAYO	90	A1			
Project No:	Project		Dwg Type	Status:			



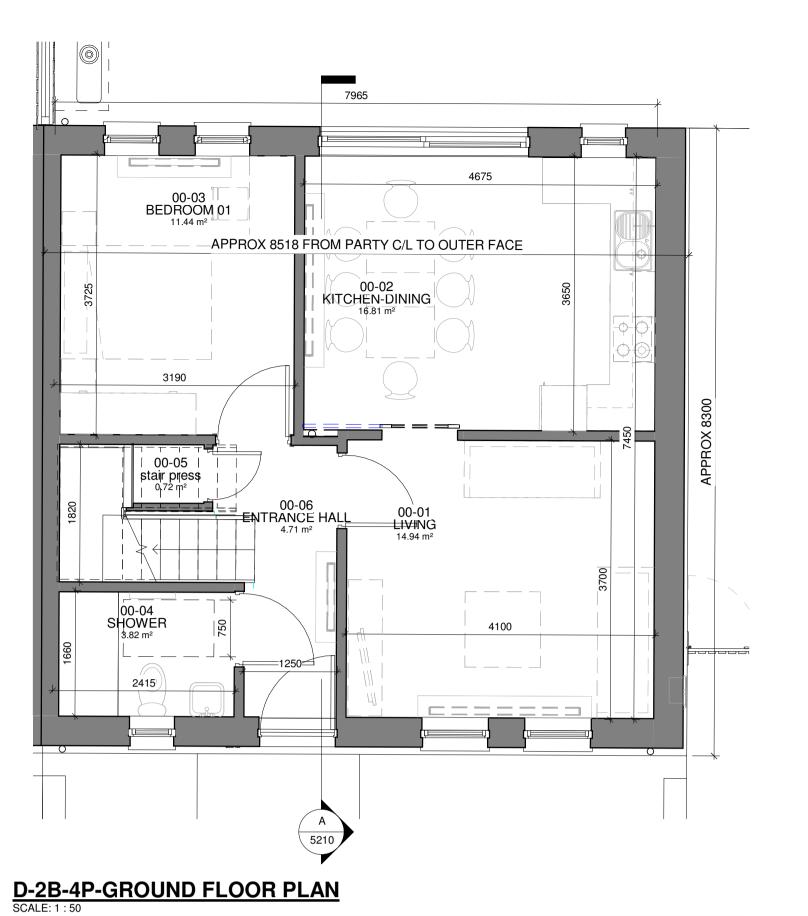

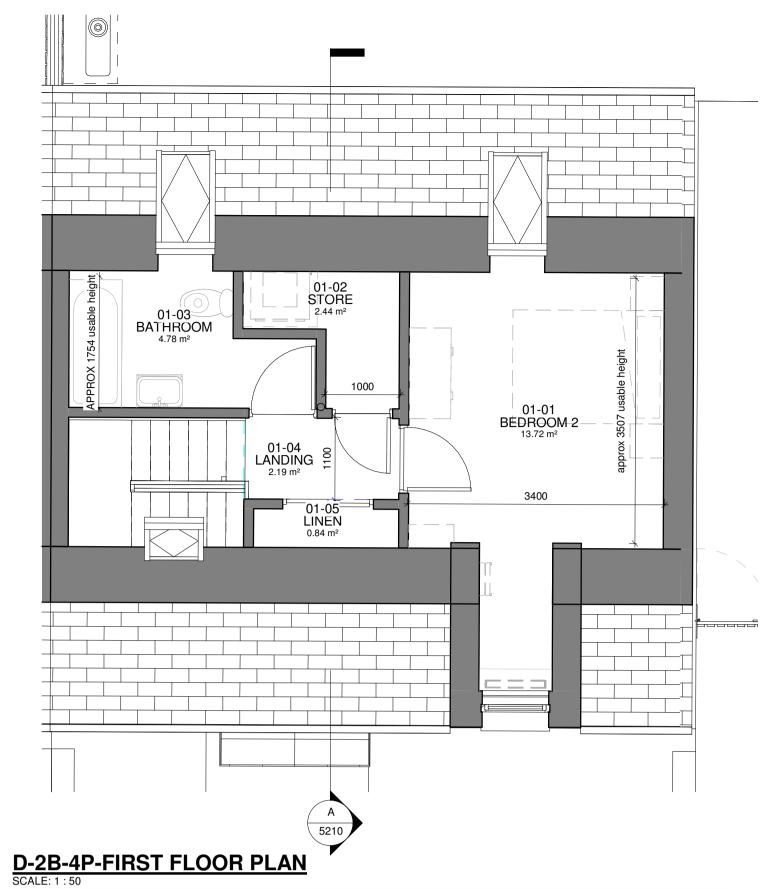

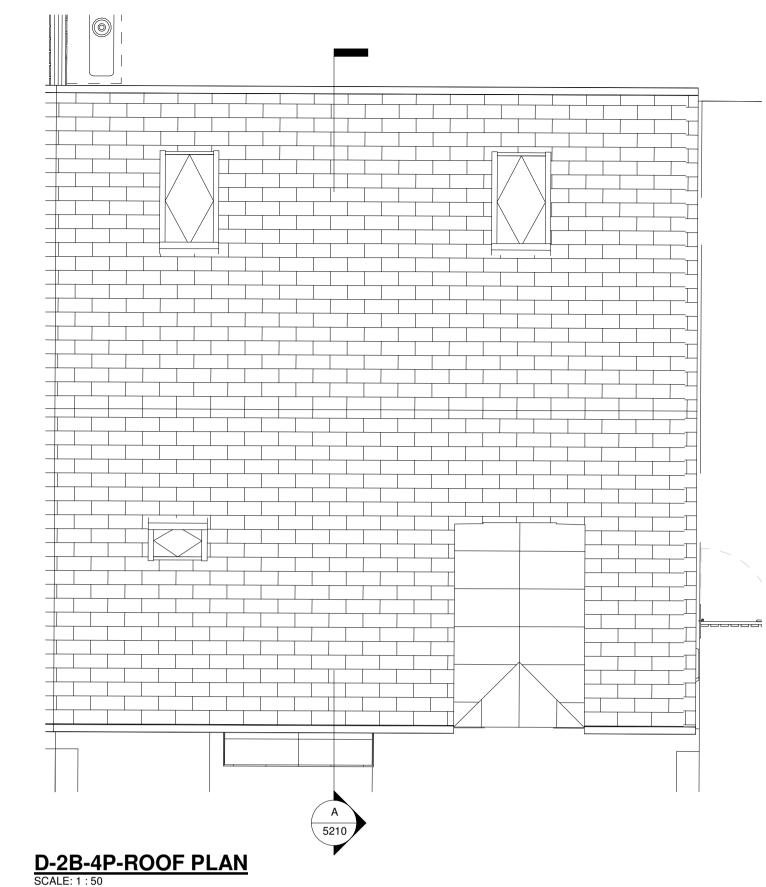

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MATERIALS: EXTERNAL ROOF FINISH: PITCHED ROOFS FINISHED IN SLATE BLUE BLACK IN (EXTERNAL) COLOUR

EXTERNAL WINDOWS & DOORS : TIMBER ALU CLAD FRAMES WITH HIGHLY EFFICIENT GLAZING (MAX 0.8W/MK) -FINISHED IN SELECTED COLOURS TO

EXTERNAL WALLS: GENERALLY MASONRY WITH RENDERED FINISH PAINTED TO SELECTED NEUTRAL COLOUR **DORMER WINDOW:** SELECTED GREY STANDING SEAM FINISH TO FEATURE

FASCIA & SOFFIT TO MATCH RAINWATER PRODUCTS.


PRE-CAST CONCRETE CILLS TO WINDOWS


DORMER WINDOW AND PORCH CANOP

CONCRETE FOOTPATHS TO PERIMETER-BRUSH FINISH

FLUSH DOOR THRESHOLD TO FRONT DOOR, WITH DRAINAGE CHANNEL TO



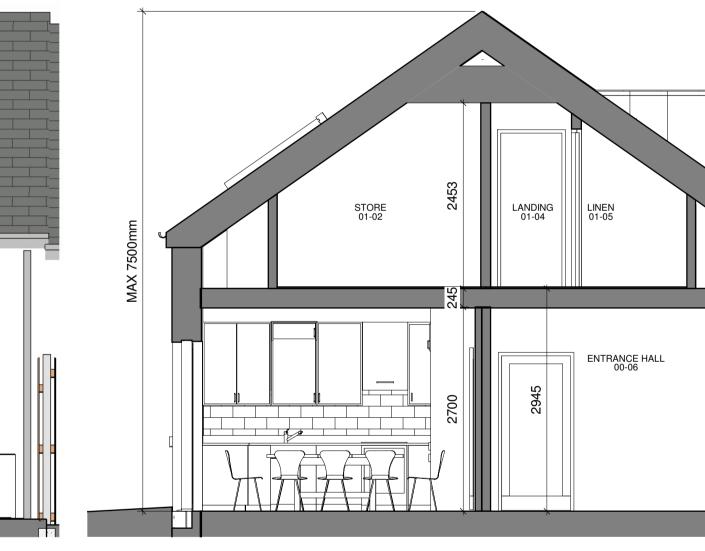

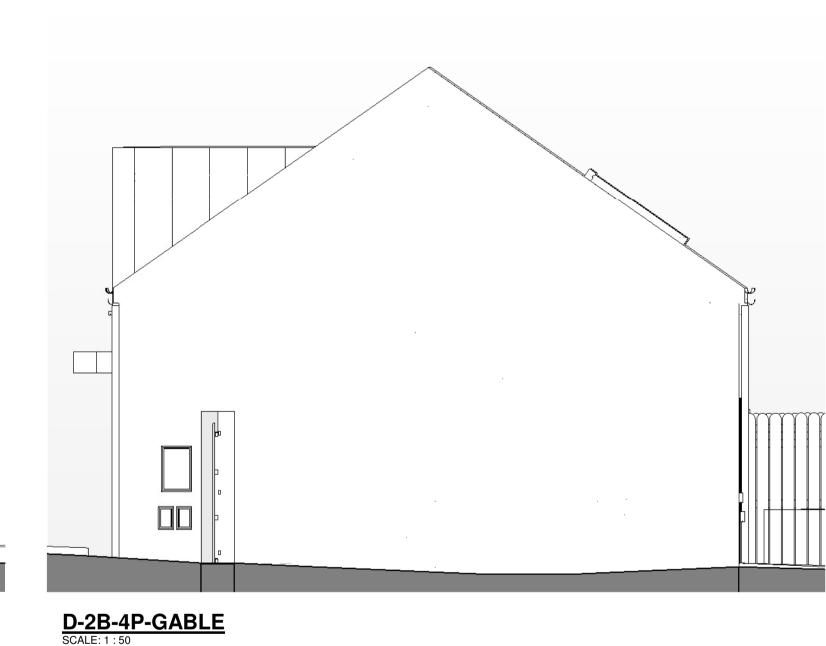

D-2B-4P-FRONT ELEVATION
SCALE: 1:50

01-05 LINEN

STATUS KEY

WORK IN PROGRESS
COORDINATION
INFORMATION
REVIEW / COMMENT
CONST APPROVAL
COSTING
TENDER
CONTRACTOR DESIGN

(99)) 2 BED (4 PERSON	N) DORMER H	OUSE TYPE-Room Schedule
NO.	Name	Area	Comments
00-01	LIVING	15 m ²	MIN 13M2
00-02	KITCHEN-DINING	17 m²	AGG TOTAL 31.85M2 (MIN 30M2)
00-03	BEDROOM 01	11 m ²	MIN 11.4M2 DOUBLE
00-04	SHOWER	4 m ²	
00-05	stair press	1 m ²	PART OF STORAGE
00-06	ENTRANCE HALL	5 m ²	
01-01	BEDROOM 2	14 m ²	MIN 13M2 MAIN DOUBLE
01-02	STORE	2 m ²	AGG TOTAL 4.2M2 (MIN 4M2)
01-03	BATHROOM	5 m ²	
01-04	LANDING	2 m ²	

(99) 2 BED (4 PERSON) DORMER HOUSE TYPE-Area Schedule				
Name	Area			
01-1ST FLOOR AREA	29 m²			
00-GROUND FLOOR AREA	58 m ²			
AREA TOTAL- 87M2				

TOTAL FLOOR AREA=87M2 (USEFUL HEIGHT-HABITABLE AREA ONLY INCLUDED). MIN TARGET **2B 4P 2 STOREY**- IS 80M2 PLUS 10% (8M2) ALLOWANCE TOTAL 88M2.

D-2B-4P-REAR ELEVATION
SCALE: 1:50

(99) 2 BED (4 PERSON) DORMER SCALE HOUSE TYPE SCHED						
	HOUSE TYPE COMMENT	UNIT NUMBER				
	DORMER-2B (4P) HANDED	UNIT 03				
	DORMER-2B (4P)	UNIT 04				
	DORMER-2B (4P) HANDED	UNIT 05				
	DORMER-2B (4P)	UNIT 06				
	DORMER-2B (4P) HANDED	UNIT 07				
	2 BED DORMER HOUSE TYPE TOTAL:	5				

D-2B-4P-SECTION ASCALE: 1:50

(99) 2 BED (4P) HOUSE TYPE 3D VIEW

ARD ADDI ICATION




		ADP APPLICA	AIIU	<u> </u>
Project	86 Housi		Dwg Type 99	Status:
Drawin Title:		2 BED (4P) DORMER HOUSE TYPE- DETAILS		Revision:
			Scale:	First Issue:
Drawn	By: cm/mw	No Orig - Cat - Lvl - Type - Role - No Status	1 . 50	JULY 2021
Checke	ed By: CM	A_586 - MCC - 99 - XX - DR - A - 5210 - A1	1:50	JULY 2021




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PART OF STORAGE

1/03/2022 An Board Plaeanale Submission



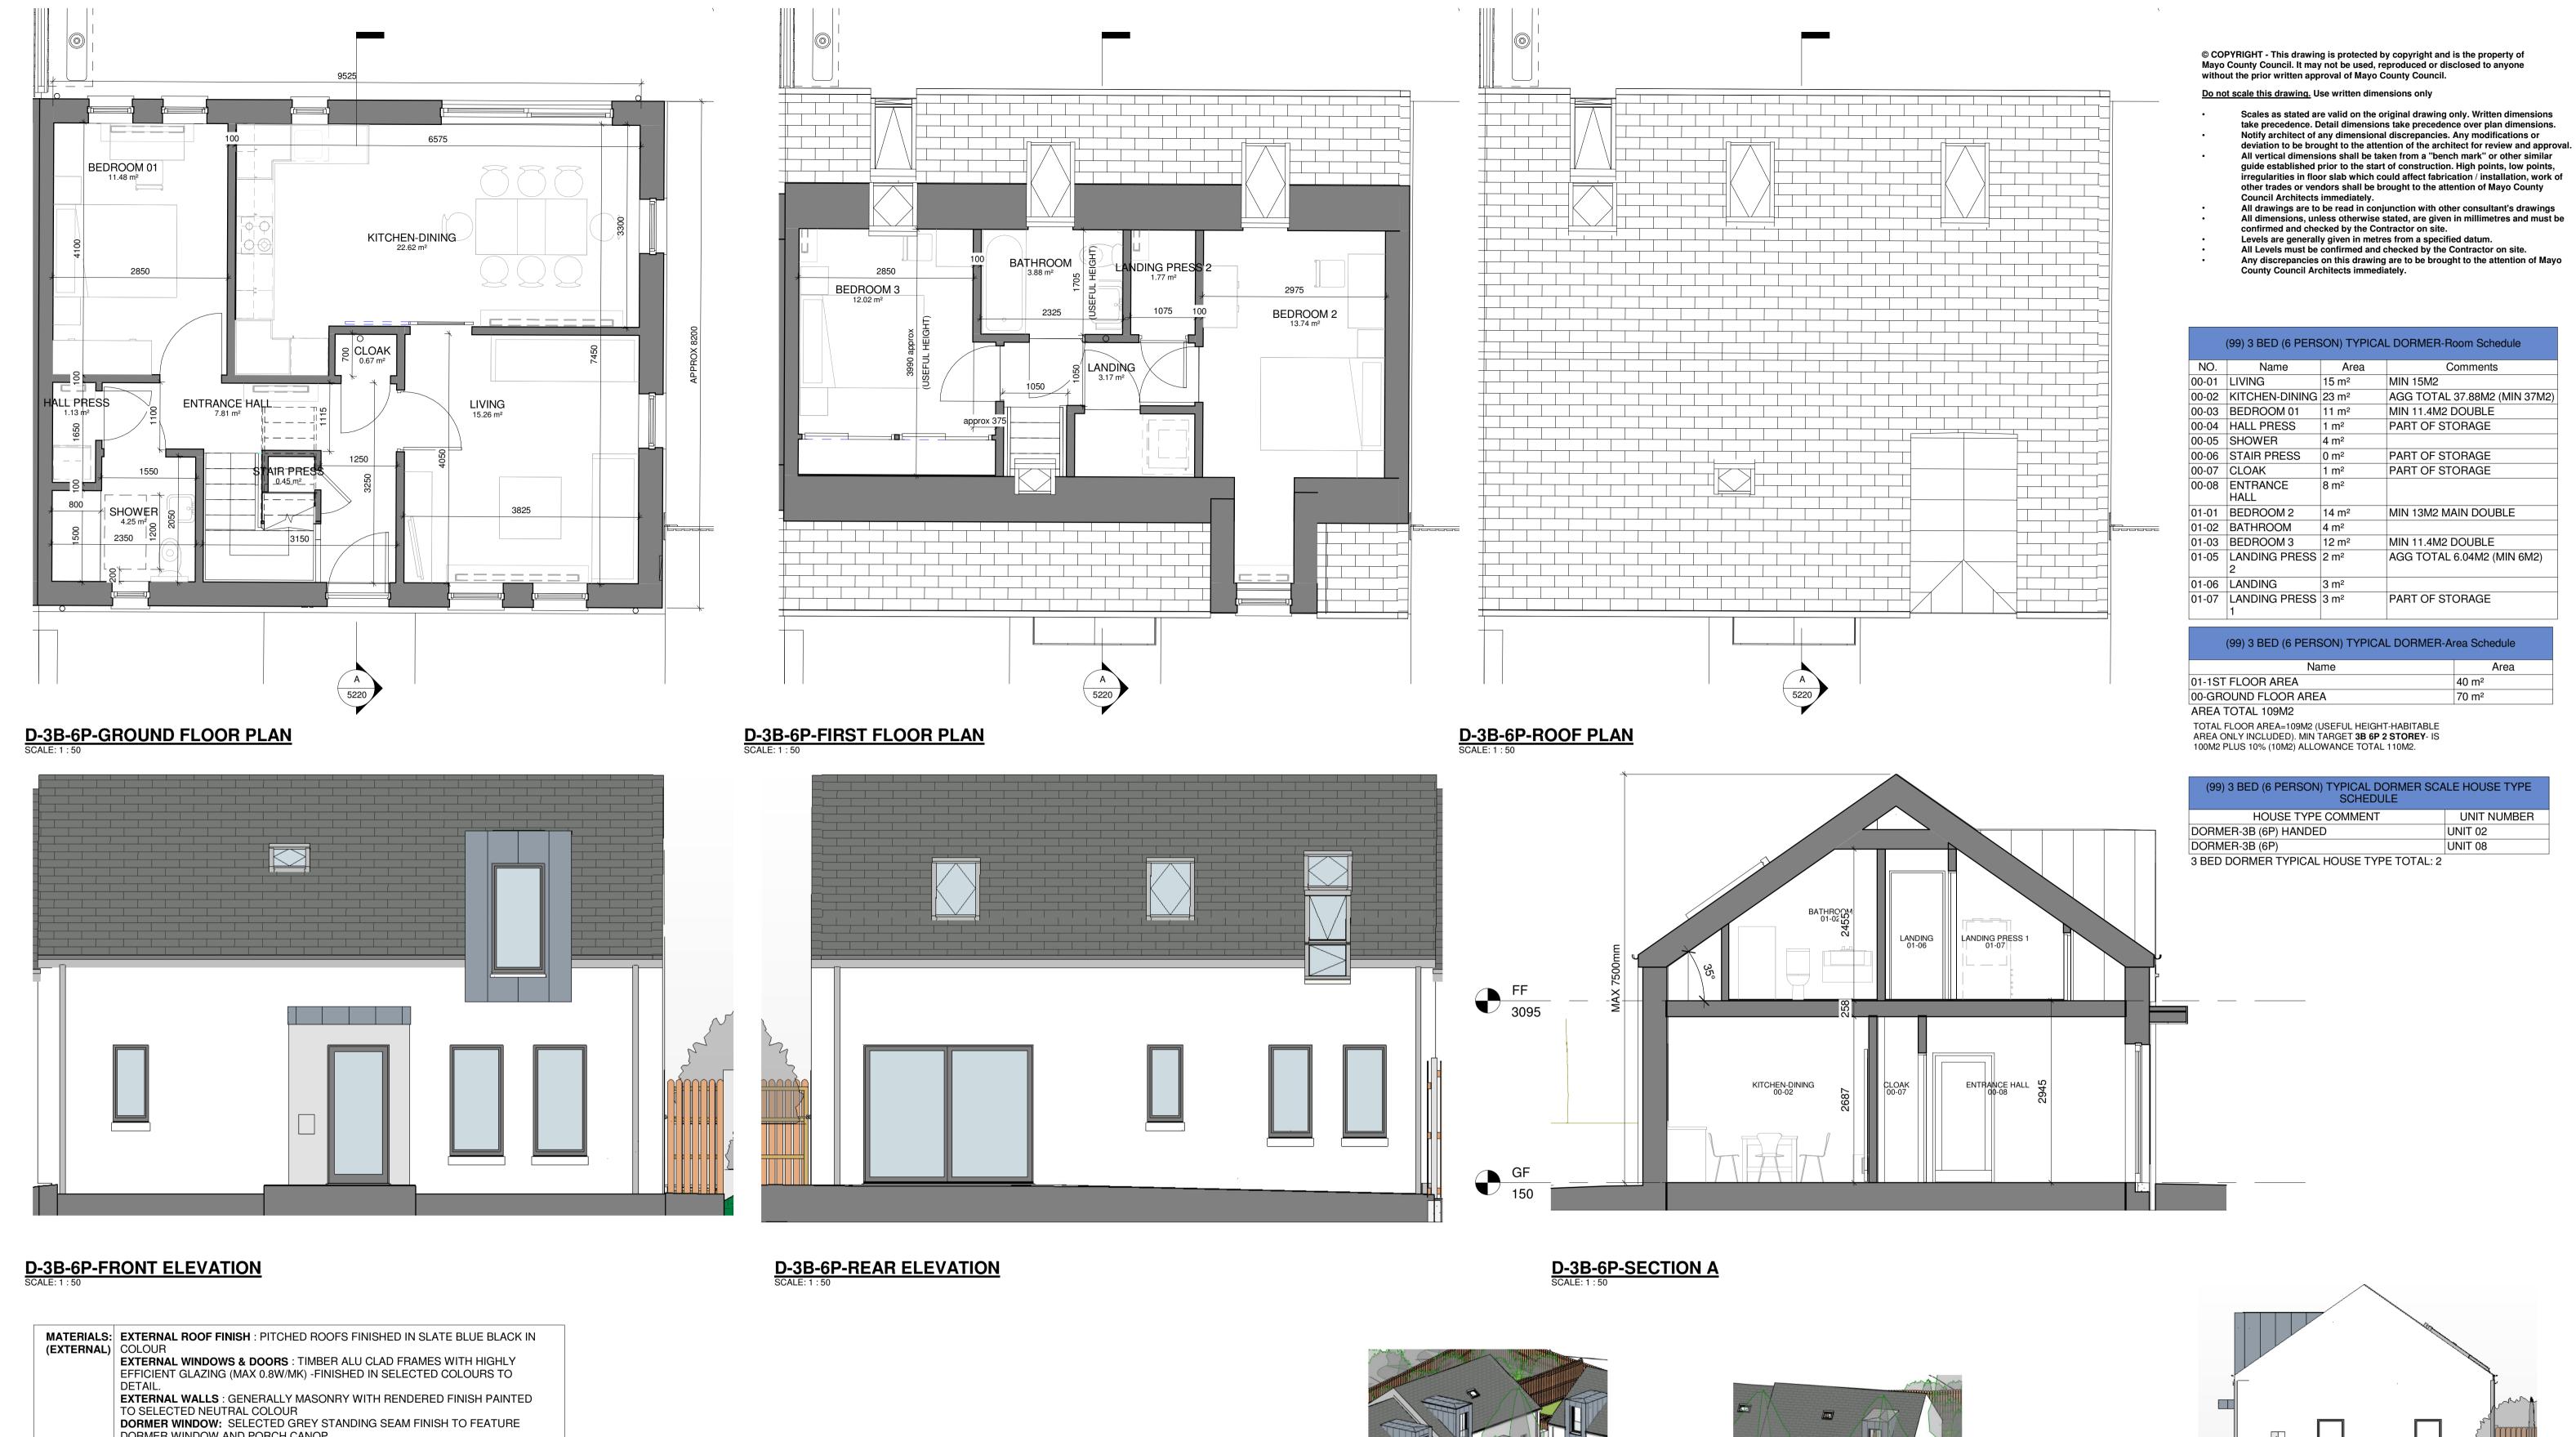

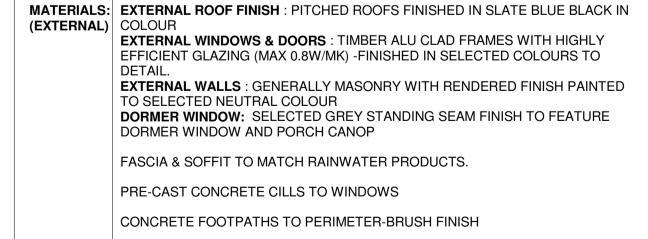ENTRANCE

FLUSH DOOR THRESHOLD TO FRONT DOOR, WITH DRAINAGE CHANNEL TO








(99) 3 BED (6P) TYPICAL DORMER 3D VIEW-UNIT 02

(99) 3 BED (6P) TYPICAL DORMER 3D VIEW-UNIT 08

D-3B-6P-GABLE ELEVATION
SCALE: 1:100

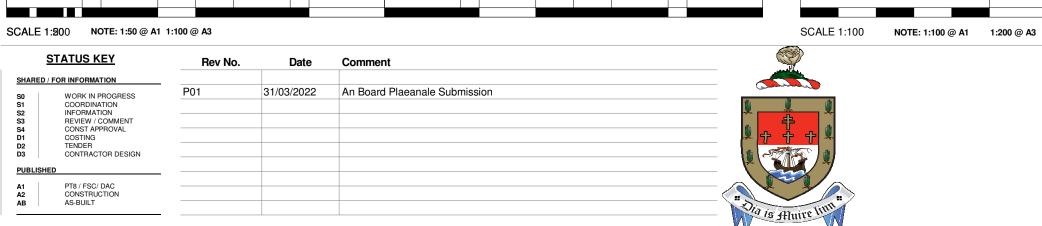

ARCHITECTS DEPARTMENT MAYO COUNTY COUNCIL



Purpose of Issue:		ABP APPLICATION		
Project No: A_586	Project Housi CROS		Dwg Type 99	Status:
Drawing Title:		D (6P) TYPICAL DORMER SE TYPE DETAILS	Drawing No. 5220	Revision:
			Scale:	First Issue:
Drawn By:	cm/mw	No Orig - Cat - Lvl - Type - Role - No Status	As indicated	JULY 2021
Checked By:	СМ	A_586 - MCC - 99 - XX - DR - A - 5220 - A1	AS mulcated	





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MAYO COUNTY COUNCIL

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1/03/2022 An Board Plaeanale Submission

STATUS KEY

WORK IN PROGRESS COORDINATION INFORMATION REVIEW / COMMENT CONST APPROVAL COSTING TENDER CONTRACTOR DESIGN

PT8 / FSC/ DAC CONSTRUCTION AS-BUILT

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SCALE 1:200 STATUS KEY SHARED / FOR INFORMATION 31/03/2022 An Board Plaeanale Submission WORK IN PROGRESS WOHK IN PHOGRESS COORDINATION INFORMATION REVIEW / COMMENT CONST APPROVAL COSTING TENDER CONTRACTOR DESIGN PT8 / FSC/ DAC CONSTRUCTION AS-BUILT

ARCHITECTS DEPARTMENT MAYO COUNTY COUNCIL



RIAI

CROSS WEST, CO. MAYO PROPOSED 3D SITE OVERVIEW Drawing No.

CHANNEL TO ENTRANCE

